

ABBREVIATIONS

AB	ANCHOR BOLT, AUGER BORING	G	GROUND, GAS LINE, GRAM	QT	QUARRY TILE
ABS	AIR BREAK SWITCH	GA	GAGE	RA	RADIUS, RISER, RUBBER SHEATH
AC	AIR CONDITIONING, ASBESTOS CEMENT, ACRES	GAL	GALVANIZED	RA	RETURN AIR
AC	ASPHALTIC CONCRETE	GC	GLAZED COATING	RAD	RADIUS
ACB	AIR CIRCUIT BREAKER	GF1	GROUND FAULT INTERRUPT	RB	RESILIENT VINYL BASE
ACSR	ALUMINUM CONDUCTOR STEEL REINFORCED	GFMU	GROUND FACE MASONRY UNIT	RCP	REINFORCED CONCRETE PIPE
ACST	ACOUSTIC	GL	GLASS	RD	ROOF DRAIN ROAD
AD	AREA DRAIN, ACCESS DOOR	GR	GRADE	RECP	RECEPTACLE
ADJ	ADJUSTABLE	GRD	GROUND	RED	REDUCING
AFF	ABOVE FINISHED FLOOR	GSU	GLAZED STRUCTURAL UNIT	REINF	REINFORCEMENT
AHU	AIR HANDLING UNIT	GW	GROUND WATER	REG	REGULATOR, REGISTER
ALT	ALTERNATE	GWB	GYPSSUM WALL BOARD GYP GYPSUM	REQD	REQUIRED
AL	ALUMINUM	HGT,H	HEIGHT, HUMIDIFIER	REV	REVISION
AM	ACOUSTIC MATERIAL	HB	HOSE BIBB	RF	ROOF, RETURN FAN
AMP,A	AMPERE	HC	HANDICAPPED	RHC	REHEAT COIL
AP	ACCESS PANEL APPROX APPROXIMATE	HD	HARD DRAWN	RHS	RUBBER INSULATED
ARCH	ARCHITECTURAL	HDW	HARDWARE	RIG	RIGID GALVANIZED STEEL
ARR	ARRESTOR	HGSW	HORN GAP SWITCH	RL	RAIN LEADER
ASPH	ASPHALT	HID	HIGH INTENSITY DISCHARGE	RM	ROOM
B	BASELINE	HORIZ	HORIZONTAL	RPM	REVOLUTIONS PER MINUTE
BO	BOARD	HP	HIGH POINT	RVT	RESILIENT VINYL TILE
BEJ	BRICK EXPANSION JOINT	HPS	HIGH PRESSURE SODIUM	S	SECOND, SOUTH, SANITARY, SEWER, STRUCTURE
BLDG	BUILDING	HR	HOUR	SAN	SANITARY SEWER
BLK	BLOCK	HS	HIGH STRENGTH	SATO	SUSPENDED ACOUSTICAL TILE CEILING
BM	BEAM	HW	HOT WATER, HEADWALL	SCH	SCHEDULE
B	BOTTOM	HWL	HIGH WATER LEVEL	SD	SPLITTER DAMPER, STORM DRAIN
BRG	BEARING	HVY	HEAVY	SE	SOUTHEAST
BR	BOTTOM REGISTER	HZ	HERTZ	SECT	SECTION SERV SERVICE SF SILT FENCE
BSMT	BASEMENT	ID	INSIDE DIAMETER, INSIDE DIMENSION	SG	SUPPLY GRILLE
C	CELSIUS	IE	INVERT ELEVATION	SH	SHEET
CAP	CAPACITY	IMC	INTERMEDIATE METAL CONDUIT	SIM	SIMILAR
CB	CIRCUIT BREAKER	INT	INTERIOR	1 PH	SINGLE PHASE
CD	CEILING DIFFUSER	INSUL	INSULATION, INSULATED	SKCP	SUSPENDED KEENE'S CEMENT PLASTER
CEM	CEMENT	INV	INVERT	SL	SLOPE
CG	CORNER GUARD	INTX	INTERSECTION	SMH	SANITARY MODULE
C&G	CURB AND GUTTER	IP	INLET PROTECTION	SP	STATIC PRESSURE, SINGLE POLE
CH	CHILLER	IRBF	INDUSTRIAL RESIN BASE FLOORING	SPC	SUSPENDED PLASTER CEILING
CI	CAST IRON, COURTYARD INLET	IBF	JUNCTION BOX	SPD	SINGLE POLE, DOUBLE THROW SPECIFICATION
CIP	CAST IRON PIPE, CAST IN PLACE	JC	JANITOR CLOSET	SPST	SINGLE POLE, SINGLE THROW SPECIFICATION
CIR	CIRCULATING	JCT	JUNCTION	SQ	SQUARE
CJ	CONTROL JOINT	JT	JOINT	SR	SUPPLY REGISTER
CKT	CIRCUIT	JST	JOIST	SS	SANITARY SEWER
CLG	CEILING	K	KILO	ST	STEAM, SINGLE THROW, STREET
C	CENTERLINE	KCP	KEENE'S CEMENT PLASTER	STA	STATION STD STANDARD
CLR	CLEAR	KG	KILOGRAM	STL	STEEL SUP SUPPORT
CMP	CORRUGATED METAL PIPE	KN	KILONEWTON	SUSP	SUSPENDED
CMPA	CORRUGATED METAL PIPE ARCH	KO	KNOCK OUT	SV	SHEET VINYL
CMU	CONCRETE MASONRY UNITS	KV	KILOVOLT	SW	SWITCH, SIDEWALK
CND,C	CONDUIT	KVA	KILOVOLT-AMPERE	SWBD	SWITCHBOARD SWGR SWITCHGEAR
CNDS	CONDENSATE	KW	KILOWATT	T	TILE, TOP TANGENT
CO	CLEANOUT	L	LITERS PER SECOND	T&B	TOP AND BOTTOM
CODP	CLEANOUT W/ DECK PLUG	LA	LOUVER, LENGTH, LENGTH OF CURVE	TC	TOP OF CURB
COL	COLUMN	LC	LEAD COVERED	TEL	TELEPHONE
COMM	COMMUNICATION	LL	LIVE LOAD	TEMP	TEMPERATURE, TEMPORARY
CONC	CONCRETE	LLH	LONG LEG HORIZONTAL	TERM	TERMINAL
COND	CONDUCTOR	LLV	LONG LEG VERTICAL	3/C	THREE CONDUCTOR
CONN	CONNECTION	LT	LIGHT	3/P	THREE POLE
CONST	CONSTRUCTION	LAV	LAVATORY VERTICAL	3 WAY	THREE WAY
CONT	CONTINUOUS	LVC	LENGTH OF VERTICAL CURVE	TH	TOTAL HEAD (PUMPS)
CONV	CONVERTER	M	METERS PER SECOND	THRSLD	THRESHOLD
COP,CU	COPPER	MACH	MACHINE	TP	TEST PIT
CP	NON-REINFORCED CONCRETE PIPE	MAS	MASONRY	TR	TOP REGISTER
CR	CHAIR, CRASH RAIL	MATL	MATERIAL	TRANS	TRANSITION
CRS	STAINLESS STEEL	MAX	MAXIMUM	TS	TOP OF STEEL, TOP OF STONE, TOP OF SLAB
CS	CONCRETE SEALER/SURFACE	ECH	ELECTRICAL	TV	TELEVISION
CSK	COUNTERSUNK	MET	METAL	TW	TOP OF WALL
CT	CERAMIC TILE, CURRENT TRANSFORMER, COOLING TOWER	MH	MANHOLE	TYP	TYPICAL
CTR	CENTER COOLING TOWER RETURN	MIN	MINIMUM, MINUTE	UG	UNDERGROUND
CTS	COOLING TOWER SUPPLY	MISC	MISCELLANEOUS	UGR	UNDER COUNTER REFRIGERATOR
CW	COLD WATER	MLO	MAIN LUG ONLY	UGE	UNDERGROUND ELECTRIC
CWB	CAPILLARY WATER BARRIER	MM,mm	MILLIMETER	UGT	UNDERGROUND TELEPHONE
CONTR	CONTRACTION	MO	MOTOR OPERATED, MASONRY OPENING, MIDDLE ORDINATE	UH	UNIT HEATER
CPT	CARPET	MP	MEDIUM PRESSURE	UNO	UNLESS NOTED OTHERWISE
D	DEPTH, DEEP, DEGREE OF CURVATURE	MTD	MOUNTING	V	VENT, VOLT, VALVE
DB	DRY BULB, DECIBEL, DIRECT BURIAL	MMP	MEMBRANE WATERPROOFING	VA	VOLT AMPRE
DD	DIVERSION DIKE	MULL	MULLION	VAC	VACUUM
DET	DETAIL	N	NORTH	VCT	VINYL COMPOSITION TILE
DH	DRILL HOLE	NA	NOT APPLICABLE	V ASB	VINYL ASBESTOS
DI	DUCTILE IRON	NC	NON CORROSIVE	VC	VARNISH CAMBRIC, VITRIFIED CLAY
DIA	DIAMETER	NE	NORTHEAST	VCP	VITRIFIED CLAY PIPE
DM	DIMENSION	NDC	NOSE DOWN CURB	VENT	VENTILATING
DL	DEAD LOAD	NEUT	NEUTRAL	VERT	VERTICAL
DMPR	DAMPER	NIC	NOT IN CONTRACT	VEST	VESTIBULE
DN	DOWN	NO	NUMBER	VPI	VERTICAL POINT OF INTERSECTION
DP	DISTRIBUTION PANEL	NOM	NOMINAL	VPOC	VERTICAL POINT OF CURVE
DS	DOWNSPOUT, STORM DRAINAGE STRUCTURE	NPS	NOMINAL PIPE SIZE	VPT	VERTICAL POINT OF TANGENT
DW	DOWNSIDE WATER	NTS	NOT TO SCALE	VRS	VENT STACK
DWG	DRAWING	NW	NORTHWEST	VTR	VENT THRU ROOF
DWD	DRINKING WATER DISPENSER	OA	OUTSIDE AIR	VWC	VINYL WALL COVERING
E	EAST	OC	ON CENTER	W	WIDTH, WASTE, WATER, WATT, WEST
EA	EACH	OCB	OIL CIRCUIT BREAKER	W	WIRE, WATER LINE STRUCTURE
EAN	EXCEPT AS NOTED	OD	OUTSIDE DIAMETER OPNG OPENING	WA	WATT
EAT	ENTERING AIR TEMPERATURE	OPP	OPPOSITE	WI	WITH
EC	EMPTY CONDUIT	OSD	OPEN SITE DRAIN	WIO	WITHOUT
EF	EACH FACE, EXHAUST FAN	OVHD,OH	OVERHEAD	WB	WET BULB
EG	EXHAUST GRILLE	P	PIPE, POLE	WC	WATER CLOSET
EL	ELEVATION	PB	PULL BOX	WD	WIDTH, WINDOW DIMENSION
ELEC	ELECTRIC	PI	POINT OF INTERSECTION	WOM	WALK OFF MATT
ELEV	ELEVATOR	PIV	POST INDICATOR VALVE	W	WATER LEVEL, WP WATERPROOF, WEATHERPROOF
EMT	ELECTRICAL METALLIC TUBING	PJF	PREFORMED JOINT FILLER	WRB	WEATHER RESISTANT BARRIER
EMER	EMERGENCY	PL	PLATE	WS	WASTE STACK, WATER SURFACE, WATERSTOP
E/P	EDGE OF PAVEMENT	PLAS	PLASTER	WT	WEIGHT
EQ	EQUAL	PLNJ	PAPER AND LEAD NEOPRENE JACKET	WWF	WELDED WIRE FABRIC
EQUIP	EQUIPMENT	PLYWD	PLYWOOD	X-FMR	TRANSFORMER
ER	EXHAUST REGISTER	PNL	PANEL	X-STR	UNIT HEATER
EVAP	EVAPORATIVE	PNT	PANT	2:1 SL	2 HORIZONTAL TO 1 VERTICAL SLOPE
EW	EACH WAY	PRELIM	PRELIMINARY	1 ON 2	1 VERTICAL ON 2 HORIZONTAL SLOPE
EWC	ELECTRIC WATER COOLER	PRESS	PRESSURE	Ø	DEFLECTION ANGLE
EXH	EXHAUST	PRIM	PRIMARY		
EXIST	EXISTING	PRV	PRESSURE RELIEF VALVE		
EXP	EXPANSION, EXPOSED	PS	PULL SWITCH		
EJ	EXPANSION JOINT	PT	POINT, POINT OF TANGENT		
EXT	EXTERIOR	PTN	PARTITION		
F	FIRE, FUSE, FILTER	PVC	POINT OF VERTICAL CURVE, POLY VINYL CHLORIDE		
FA	FIRE ALARM FABX FIRE ALARM BOX	PVI	POINT OF VERTICAL INTERSECTION		
FD	FLOOR DRAIN, FIRE DAMPER				
FDN	FOUNDATION				
FE	FIRE EXTINGUISHER				
FFE	FINISHED FLOOR ELEVATION				
FH	FIRE HYDRANT				
FHC	FIRE HOSE CABINET				
FIG	FIGURE				
FIN	FINISH				
FL	FLOOR, FLASHING, FLOW LINE				
FLUOR	FLUORESCENT				
4 WAY	FOUR WAY				
FPH	FROST PROOF HYDRANT				
FR	FRAME				
FS	FULL SIZE				
FTG	FOOTING				
FJ	FELT JOINT				
FW	FIRE WATER				
FXTR	FIXTURE				

ARCHITECTURAL SYMBOLS

0 COLUMN GRID LINE

01 / SHEET MATCHLINE AND VIEW REFERENCE

CENTERLINE

7'-0" 48.11" 99.917"

ROOM NAME RM # XXX SF

DOOR NUMBER MINIMUM CLEARANCES

WALL TYPE TAG

STOREFRONT TAG

CURTAIN PANEL TYPE

KEYNOTE

LEVEL DATUM

DETAIL - SECTION

DETAIL - PLAN/RCP

BUILDING SECTION

WALL SECTION

EXTERIOR ELEVATION

INTERIOR ELEVATION


VIEW TITLE

INTERIOR FINISH TAG

GRAPHIC SCALE 0 4'-0" 8'-0" 16'-0"

MATERIALS LEGEND

CONCRETE (SECTION)	DEMOLISHED WALL (PLAN & SECTION)
GRANULAR FILL	STEEL (SECTION)
CONCRETE MASONRY UNITS	WOOD FINISH (SECTION)
BRICK	2x WD STUD
RIGID INSULATION (SECTION)	SHIM AS REQ'D
ACOUSTIC/THERMAL INSULATION (SECTION)	LUMBER FINISH (SECTION)
STUD WALL (PLAN & SECTION)	EARTHWORK (SECTION)

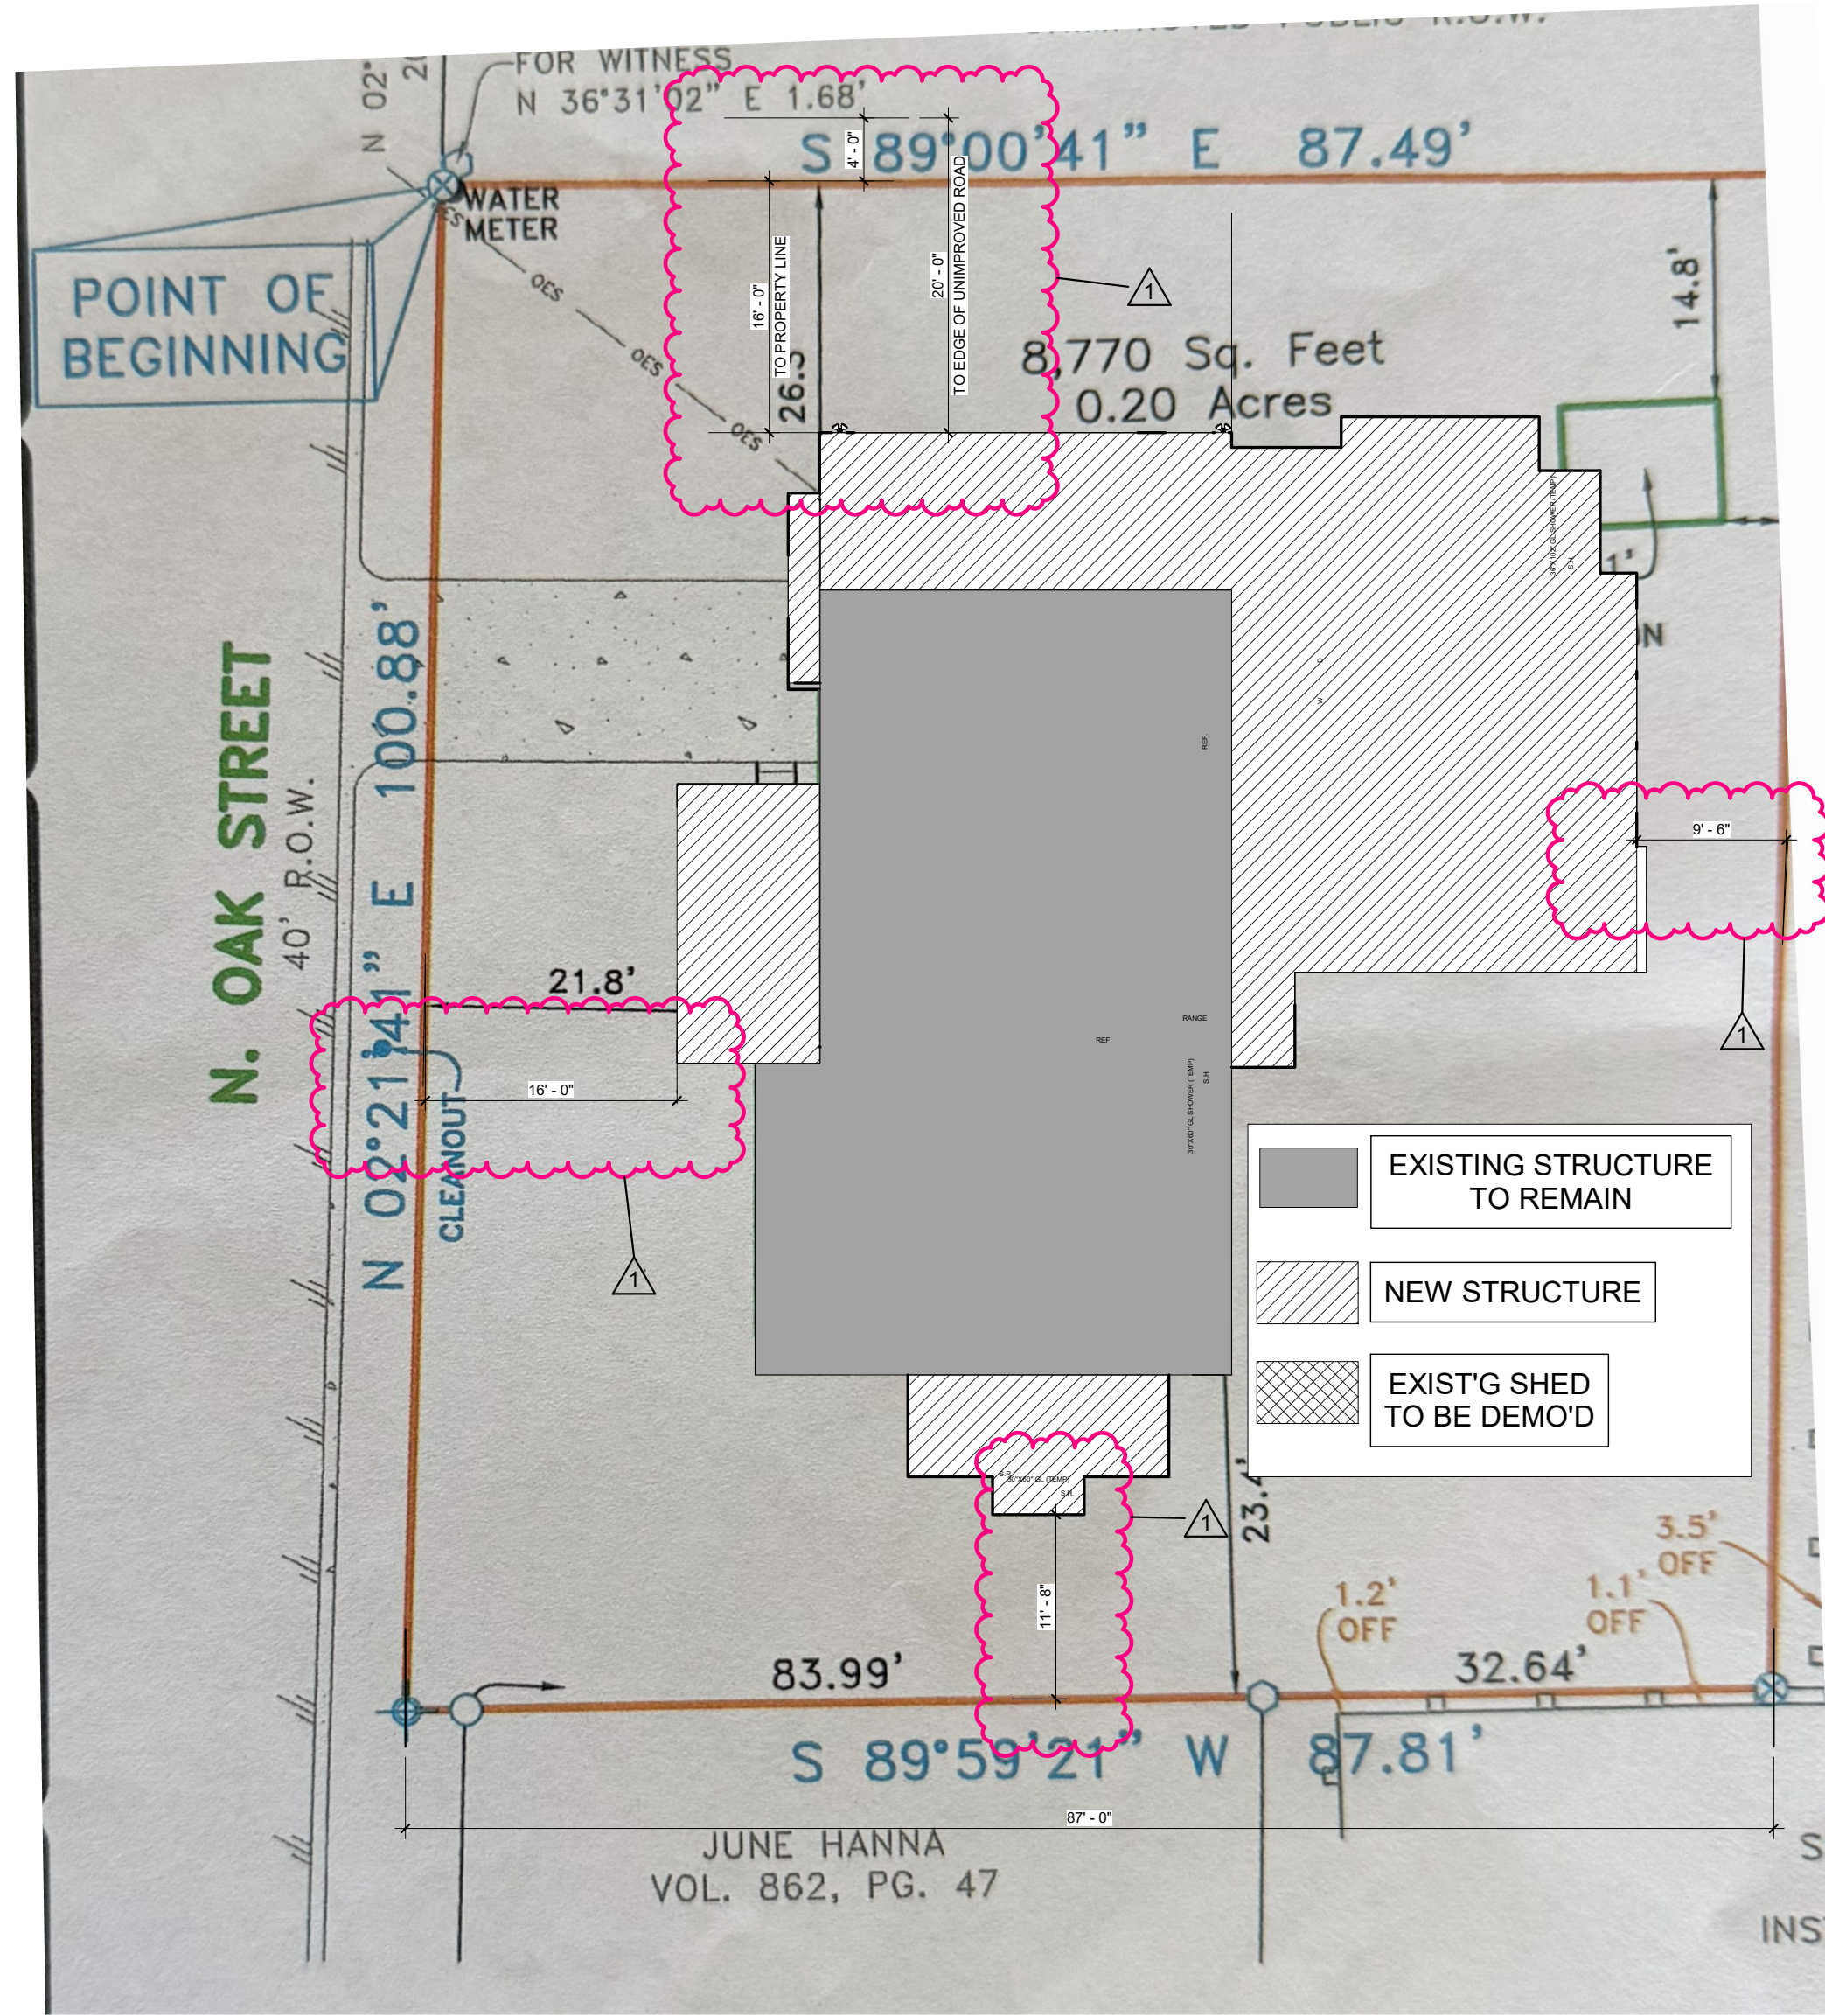

01 ARCHITECTURAL SITE PLAN 3/32" = 1'-0"

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Revision

MARK	DATE	DESCRIPTION
1	04/29/2026	City Comments

Project Number 25012
Original Issue 03/16/2026

Seal



03/16/2026

Sheet Name

SYMBOLS, GENERAL NOTES & SURVEY

Sheet Number

A-001

Project Status
PERMIT SET