

GENERAL FLOOR PLAN NOTES

MAXIMUM DIMENSIONS U.N.O.

- PLAN DIMENSIONS ARE FROM FACE OF GYP. BD., FACE OF EXPOSED CMU, EXT. FACE OF MASONRY OR CONC. PANEL, COLUMN GRID LINE, FACE OF EXISTING WALL, AND/OR CENTERLINE OF MULLION AND DOOR OPENINGS U.N.O.
 MASONRY DIMENSIONS ON PLAN ARE NOMINAL. MASONRY OPENING SIZES MAY BE ADJUSTED AS REQD. TO ALLOW FOR JOINT WIDTHS AND UNIFORM
- MASONRY COURSING.


 3. DIMENSIONS NOTED AS CLEAR (CLR.) ARE FROM FACE OF FINISHED WALL SURFACE. CLEAR DIMENSIONS ARE CRITICAL AND ARE NOT MINIMUM OR
 - 4. FURNITURE, FIXTURES AND EQUIPMENT SHOWN DASHED ARE FOR REFERENCE ONLY AND ARE NOT IN CONTRACT U.N.O.
 - 5 DEED TO SINICH DI ANI AND/OD SINICH SOLEDI II E SOD WALL DROTE.
 - 5. REFER TO FINISH PLAN AND/OR FINISH SCHEDULE FOR WALL PROTECTION LOCATIONS.
 - 6. REFER TO SHEETS A-411 AND A-412 FOR TYPICAL GUIDELINES FOR ACCESSIBLE ELEMENTS, ACCESSORIES, AND FIXTURES AT TOILETS, URINAL, AND SHOWER STALLS, DRINKING FOUNTAINS, ETC.

FLOOR PLAN KEYED NOTES ①

- NOT ALL KEYED NOTES APPLY TO ALL SHEETS.
- 1. ANCHOR APPARATUS
- CRAWL SPACE EXHAUST
 EXISTING CRAWL SPACE EXHAUST
- 4. GENERATOR FOUNDATION, REF. STRUCT.
- 5. STORAGE CUBBIES REF. 06/A-405



KEY PLAN

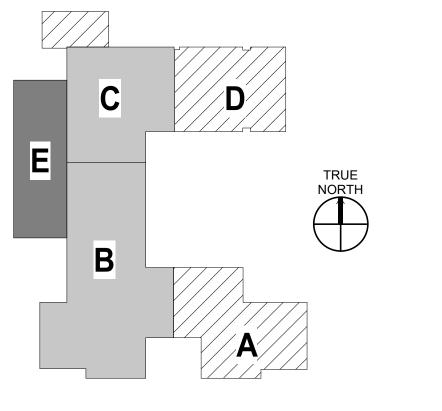



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PHASE 5

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revision no:	issue date:
PR 01	03/01/21
PR 02	03/08/21

10/02/2020 vai project no:


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sheet title:

DIMENSIONAL CONTROL FLOOR PLAN - AREAS B & C

A-110



GENERAL FLOOR PLAN NOTES
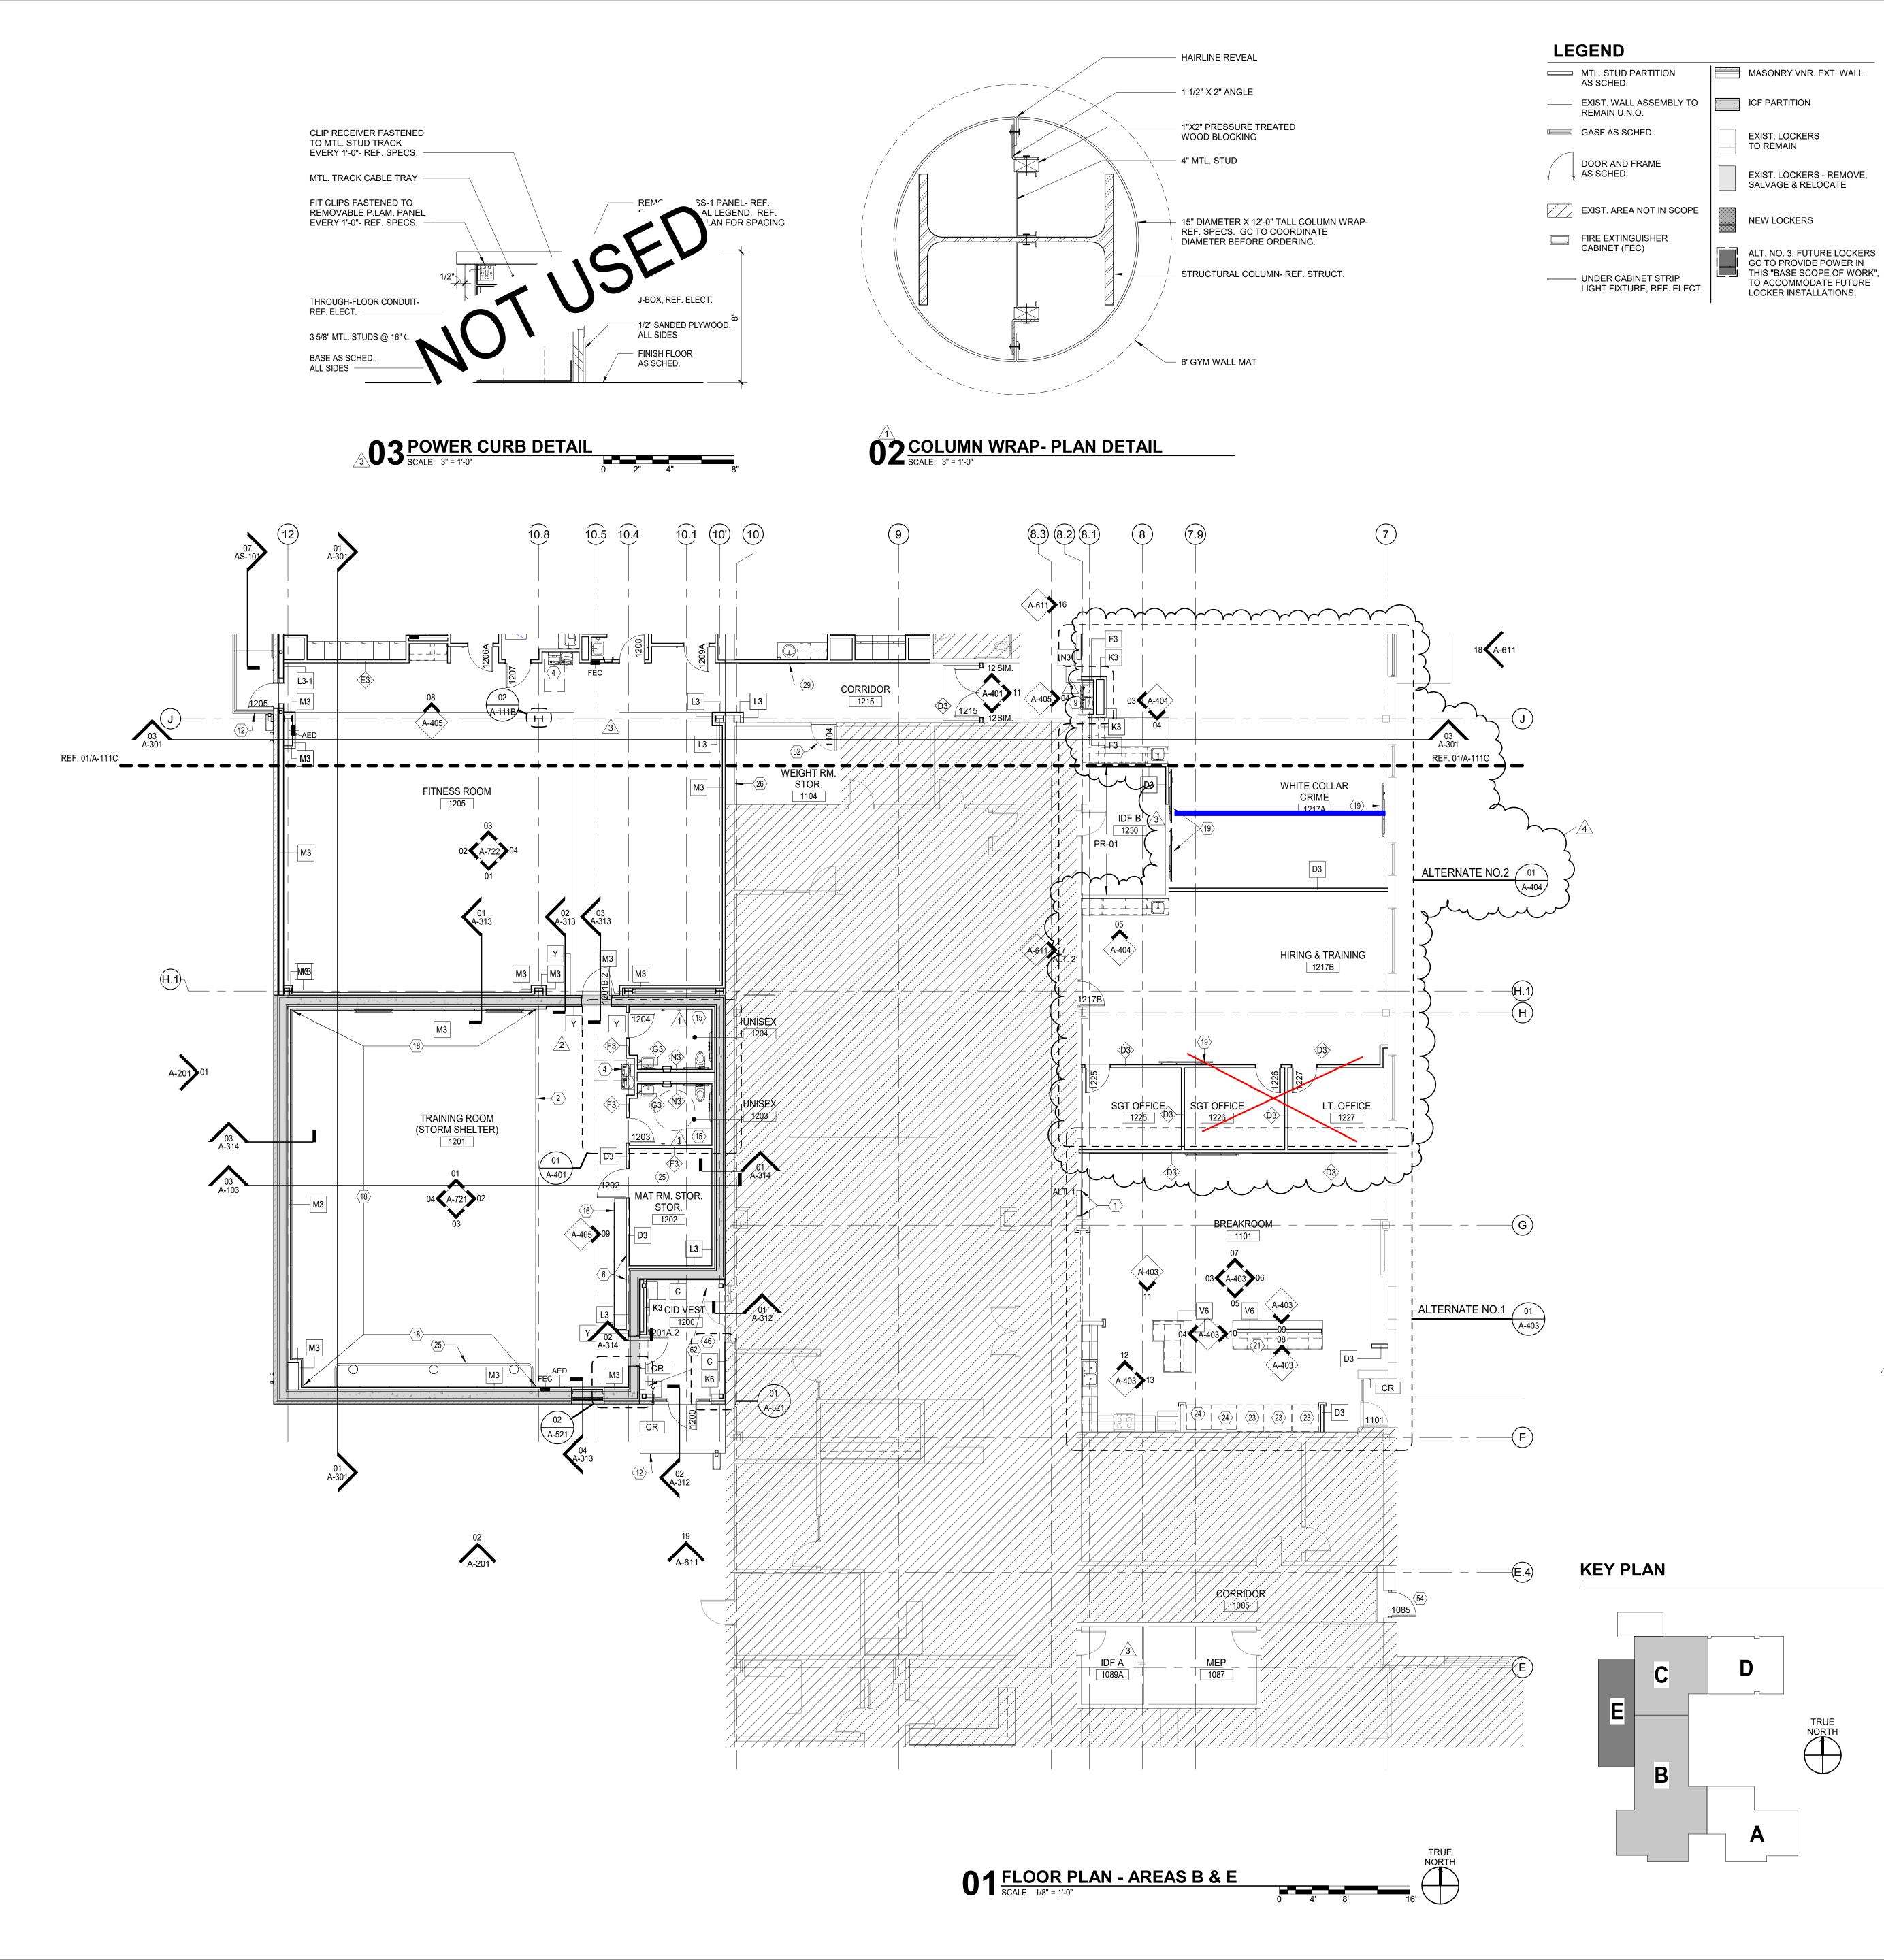
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KEYED NOTES

- NOT ALL KEYED NOTES APPLY TO ALL SHEETS.
- 1. PARTITION WALL INFILL TO MATCH EXISTING CONSTRUCTION.
- 2. TRAINING MAT. REF. A-631
- 3. LOCKERS AND BENCH, REF. A-732
- 4. EWC W/BOTTLE FILLER, REF. PLUMB. REF. DETAIL 01A / A-411.
- VEST DRYING CABINET
- ALIGN SURFACES
- 7. FIRE EXTINGUISHER CABINET
- EXISTING REUSED
- 10. EXISTING CRAWL SPACE VENT TO REMAIN

9. EXISTING EWC SALVAGED FOR REUSE. REF. DETAIL 01A / A-411.

- 11. CRAWL SPACE AIRWAY VENT REF. MEP & STRUCTURAL
- 12. CANOPY ABOVE 13. EXISTING MILLWORK TO REMAIN.
- 14. 36" x 36" FLOOR ACCESS HATCH W/ LADDER BELOW- REF. SPECS.
- 15. BENCH SEATING NON-FIXED CF/CI
- 16. STORAGE CUBBIES REF. 06/A-405
- 17. TRAINING APPARATUS REF. SPEC'S. CF/CI
- 18. GYM WALL MAT, CF/CI
- 19. FLAT PANEL TV, CF/CI MNT. CENTER- REF. MEP FOR ELECT.
- 20. TACK BOARD MOUNT BOTTOM AT 42" AFF.
- 21. BUFFET ISLAND 22. TABLE SEATING- FFE
- 23. "HEALTHY CHOICE" VENDING MACHINES BY VENDOR REF. ELEC. FOR POWER.
- 24. EXISTING REFRIGERATOR RELOCATED
- 25. APPARATUS TRAINING EQUIPMENT REF SPEC'S.
- 26. ELECTRICAL PANELS- REF. MEP
- 27. LOW CURB FOR POWER, DATA & AV- REF. MEP
- 28. 12" DIAMETER GROMMET W/ STAINLESS STL. COLLAR FOR TRASH BIN BELOW
- 29. 72"w x 48"h WHITE MARKER BOARD MOUNT BTM AT 42" AFF
- 30. SOLID SURFACE COUNTERTOP AND BACKSPLASH
- 31. NEW SINK & FAUCET REF. MEP
- 32. REINSTALLED EXISTING DISHWASHER
- 33. REINSTALLED EXISTING RANGE 34. REINSTALLED EXISTING ICE MAKER
- 35. REINSTALLED EXISTING MICROWAVE
- 36. COUNTERTOP, SS-1
- 37. 4" BACK SPLASH & SIDE SPLASH WHERE APPLICABLE, SS-1 3/8" THK.
- 38. CONCEALED COUNTERTOP SUPPORT BRACKET W/ MFR'S. TRIM AT WALL PENETRATION
- 39. BASE CABINET, PL-1
- 40. UPPER CABINET, PL-1. UNDER CABINET LIGHTING- REF. ELECT.
- 41. GYP. BD. WALL, PT-1
- 42. BASE AS SCHED., RB-1 43. ACCESSIBLE COUNTER AT 34" AFF
- 44. PATCH & REPAIR DAMAGED GYP. BD. FOLLOWING REMOVAL OF EXISTING LOCKERS AND BENCHES. PREPARED SURFACES TO MATCH EXISTING SURROUNDING MATERIAL AND TEXTURE. PAINT FULL WIDTH AND HEIGHT OF REPAIRED PARTITION SURFACE. PAINT COLOR AND SHEEN TO MATCH EXISTING SURROUNDING WALL SURFACES. COLOR MATCH IF NECESSARY.
- 45. OPEN SHELVING, PL-2 THROUGHOUT ON ALL SURFACES
- 46. WALK-OFF MAT SET IN DEPRESSED SLAB 1-1/2" REF. STRUCTURAL
- 47. NEW REFRIGERATORS W/ STAINLESS STEEL FINISH, CF/CI
- 48. DUPLEX RECEPTACLE
- 49. MAGNETIC MARKER BOARD MOUNT BTM. AT 42" AFF
- 50. FULL HEIGHT BACK SPLASH & SIDE SPLASH, SS-1, 3/8" THK.
- 51. NOT USED
 - 52. INSTALL REPLACEMENT HARDWARE REF. SPECS.
 - 53. 5/8" GYP. BD. BOTH SIDES ON 3 5/8" MTL. STUD FURR DOWN W/ DIAGONAL BRACING AS REQ'D. ABOVE CEILING
 - 54. INSTALL NEW DOOR HARDWARE, FRAME & DOOR w/ SINGLE FULL LITE GLASS.
- 55. NEW MECHANICAL YARD SCREEN WALL. BRICK VENEER OVER CMU MATCH EXISTING. REF. DETAILS. REF. CIVIL & STRUCTURAL
- 56. STOREFRONT WINDOW, ALT #2 SCOPE
- 57. UNDERCOUNTER REFRIGERATOR- CF/CI.
- 58. FINISHED END
- 59. RECESSED DRYER VENTING BOX
- 60. WASHING MACHINE OUTLET BOX 61. P.LAM. PANEL, PL-1 WITH BLACK EDGE BANDING AT REVEALS. REF. ELEVATION
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- 63. ADA LOCKERS- REF. A-732
- 64. 20"x48" BENCH AT 17"-19" AFF. CF/CI

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ADDENDUM #1 11/11/20 03/01/21 PR 02 03/08/21


vai project no:

20204.000 GC

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FLOOR & CLERESTORY PLAN

- AREAS B & E

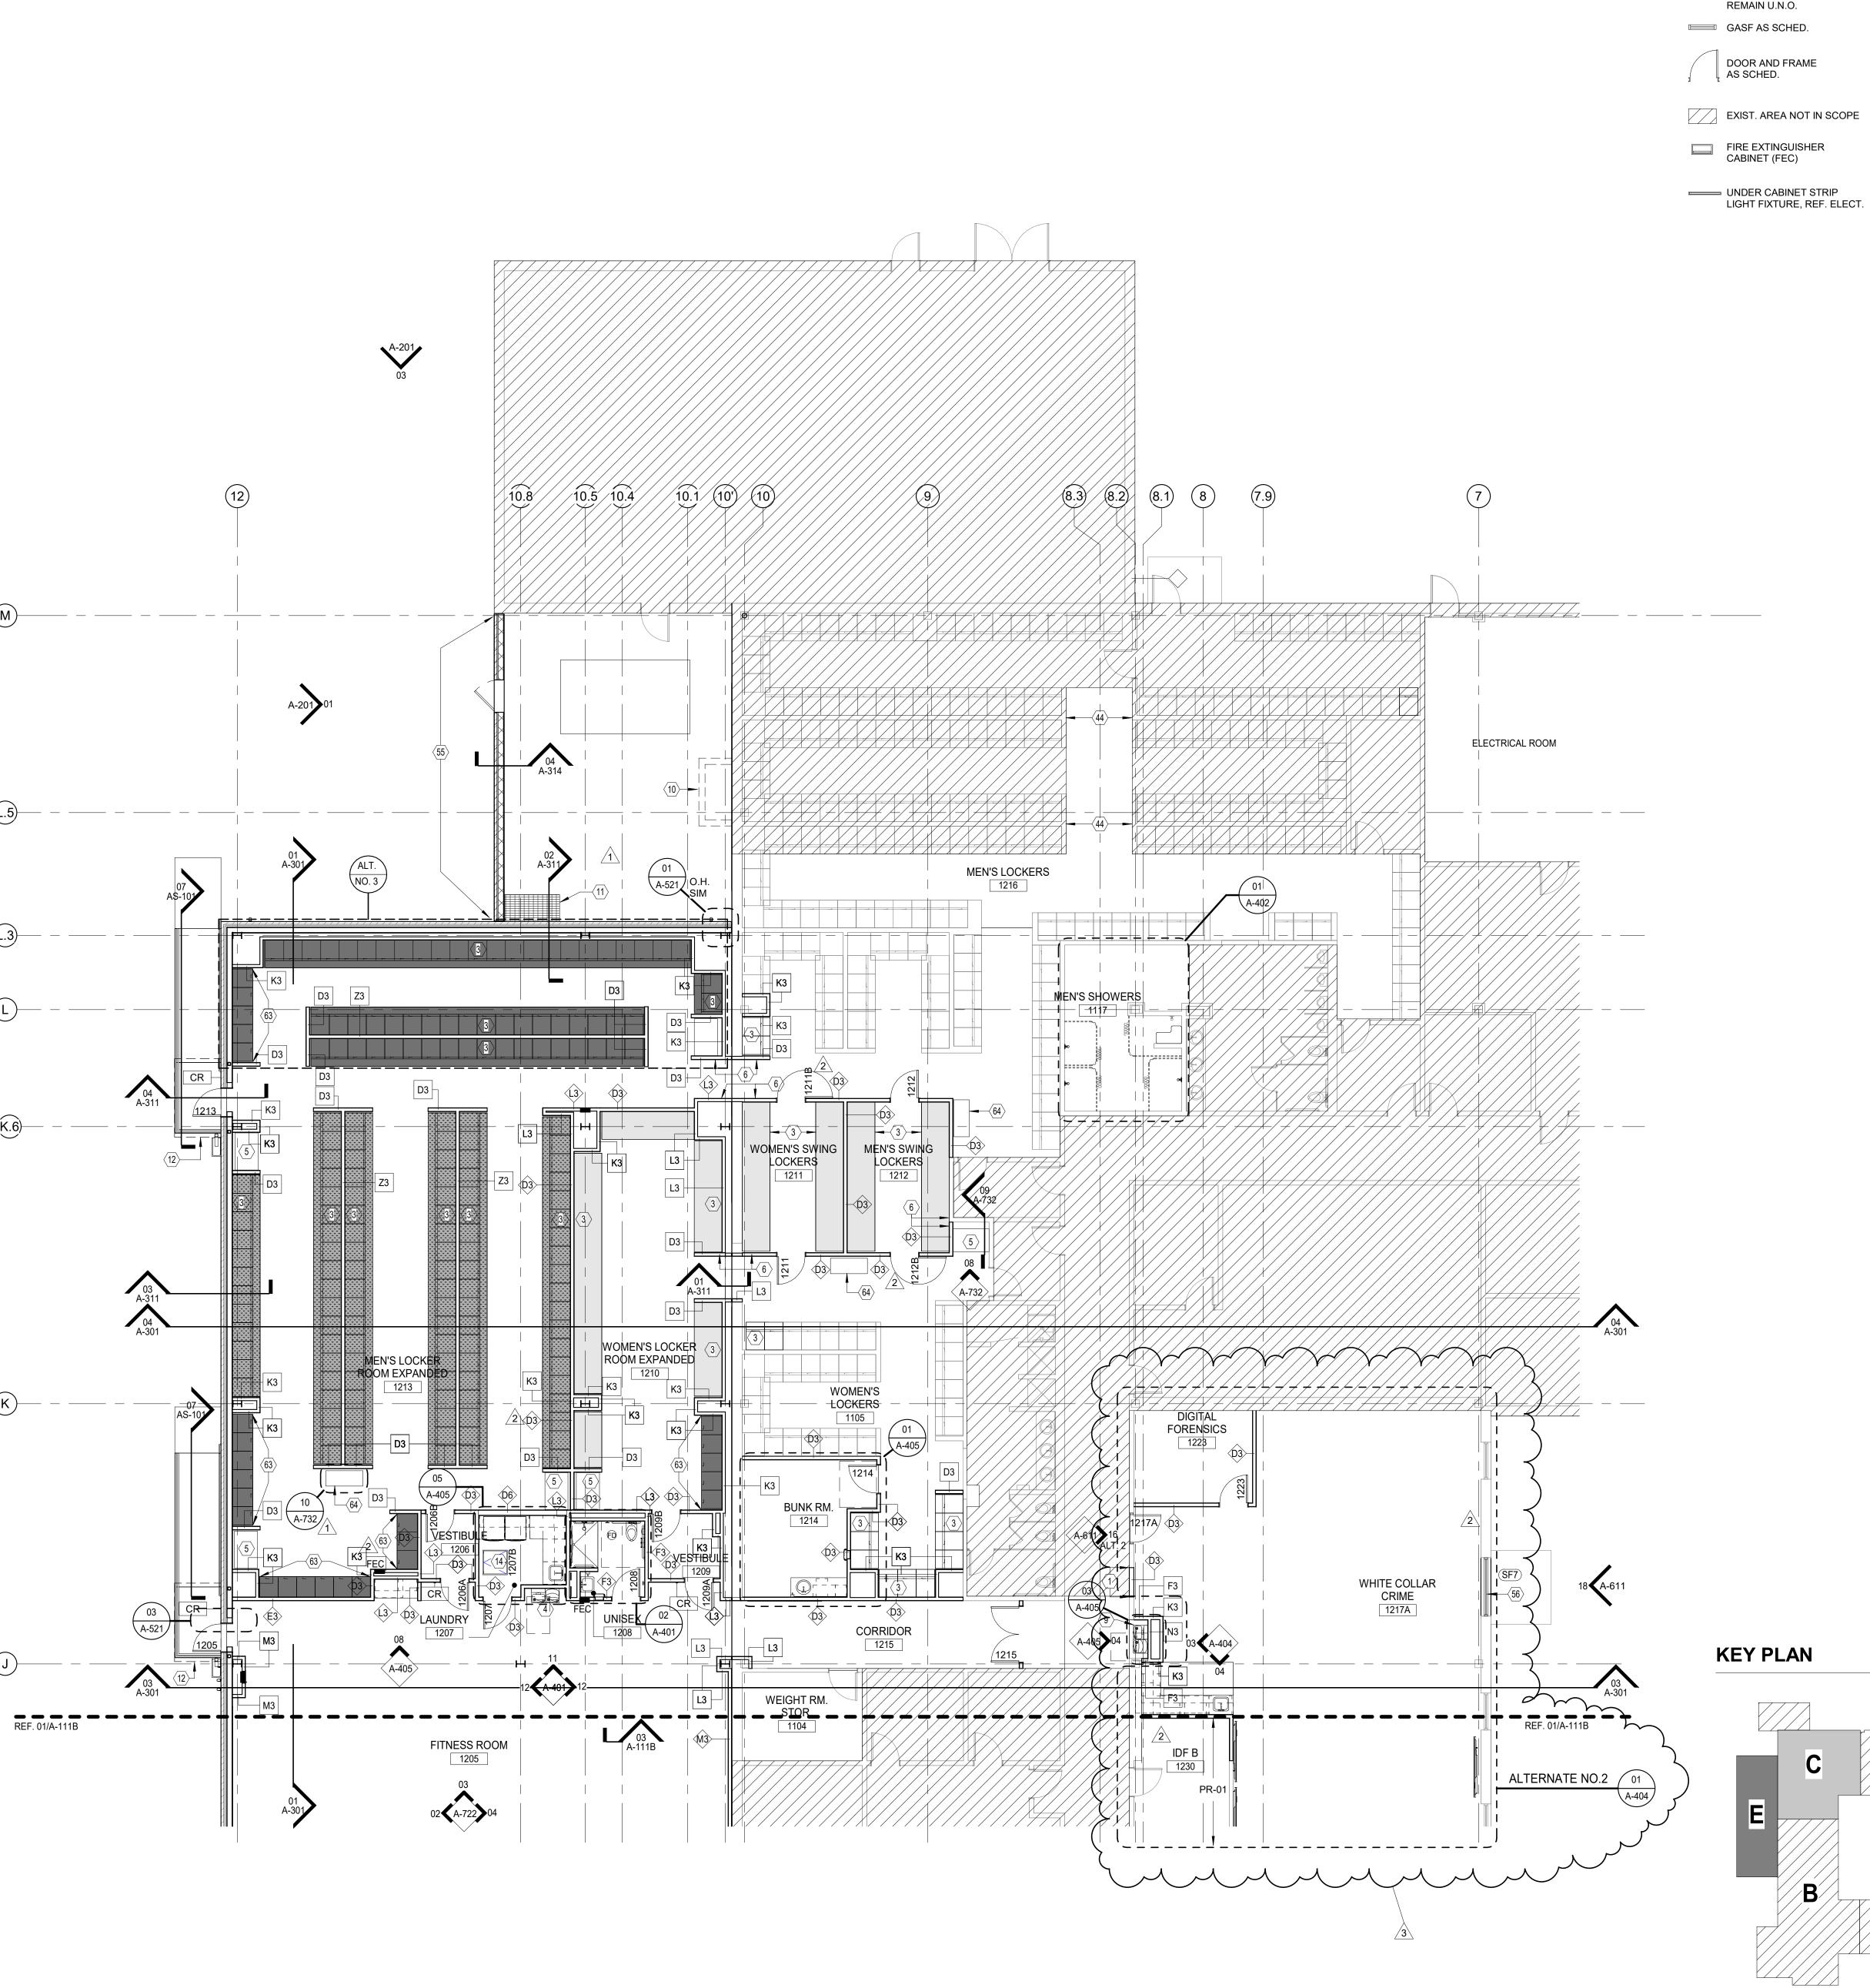

GENERAL FLOOR PLAN NOTES

MASONRY VNR. EXT. WALL 1. PLAN DIMENSIONS ARE FROM FACE OF GYP. BD., FACE OF EXPOSED CMU, EXT. FACE OF MASONRY OR CONC. PANEL, COLUMN GRID LINE, FACE OF EXISTING WALL, AND/OR CENTERLINE OF MULLION AND DOOR OPENINGS U.N.O.

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16. STORAGE CUBBIES - REF. 06/A-405

17. TRAINING APPARATUS - REF. SPEC'S. CF/CI

18. GYM WALL MAT, CF/CI

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36. COUNTERTOP, SS-1

37. 4" BACK SPLASH & SIDE SPLASH WHERE APPLICABLE, SS-1 3/8" THK.

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58. FINISHED END

59. RECESSED DRYER VENTING BOX

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62. WALK-OFF GRATE- REF. STRUCT. FOR CONCRETE DEPRESSION

63. ADA LOCKERS- REF. A-732

64. 20"x48" BENCH AT 17"-19" AFF. CF/CI

LEGEND

EXIST. WALL ASSEMBLY TO ICF PARTITION

EXIST. LOCKERS TO REMAIN

NEW LOCKERS

EXIST. LOCKERS - REMOVE, SALVAGE & RELOCATE

ALT. NO. 3: FUTURE LOCKERS

THIS "BASE SCOPE OF WORK",

TO ACCOMMODATE FUTURE

LOCKER INSTALLATIONS.

GC TO PROVIDE POWER IN

AS SCHED.

01 FLOOR PLAN - AREAS C & E
SCALE: 1/8" = 1'-0"

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POLICE DEPARTMENT

McKINNEY PUBLIC SAFETY BUILDING

2200 TAYLOR BURK DR. McKINNEY, **TEXAS 75071**

PHASE 5

1	ADDENDUM #1	10/21/20
2	PR 01	03/01/21
3	PR 02	03/08/21


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FLOOR PLAN -AREAS C & E

A-111C





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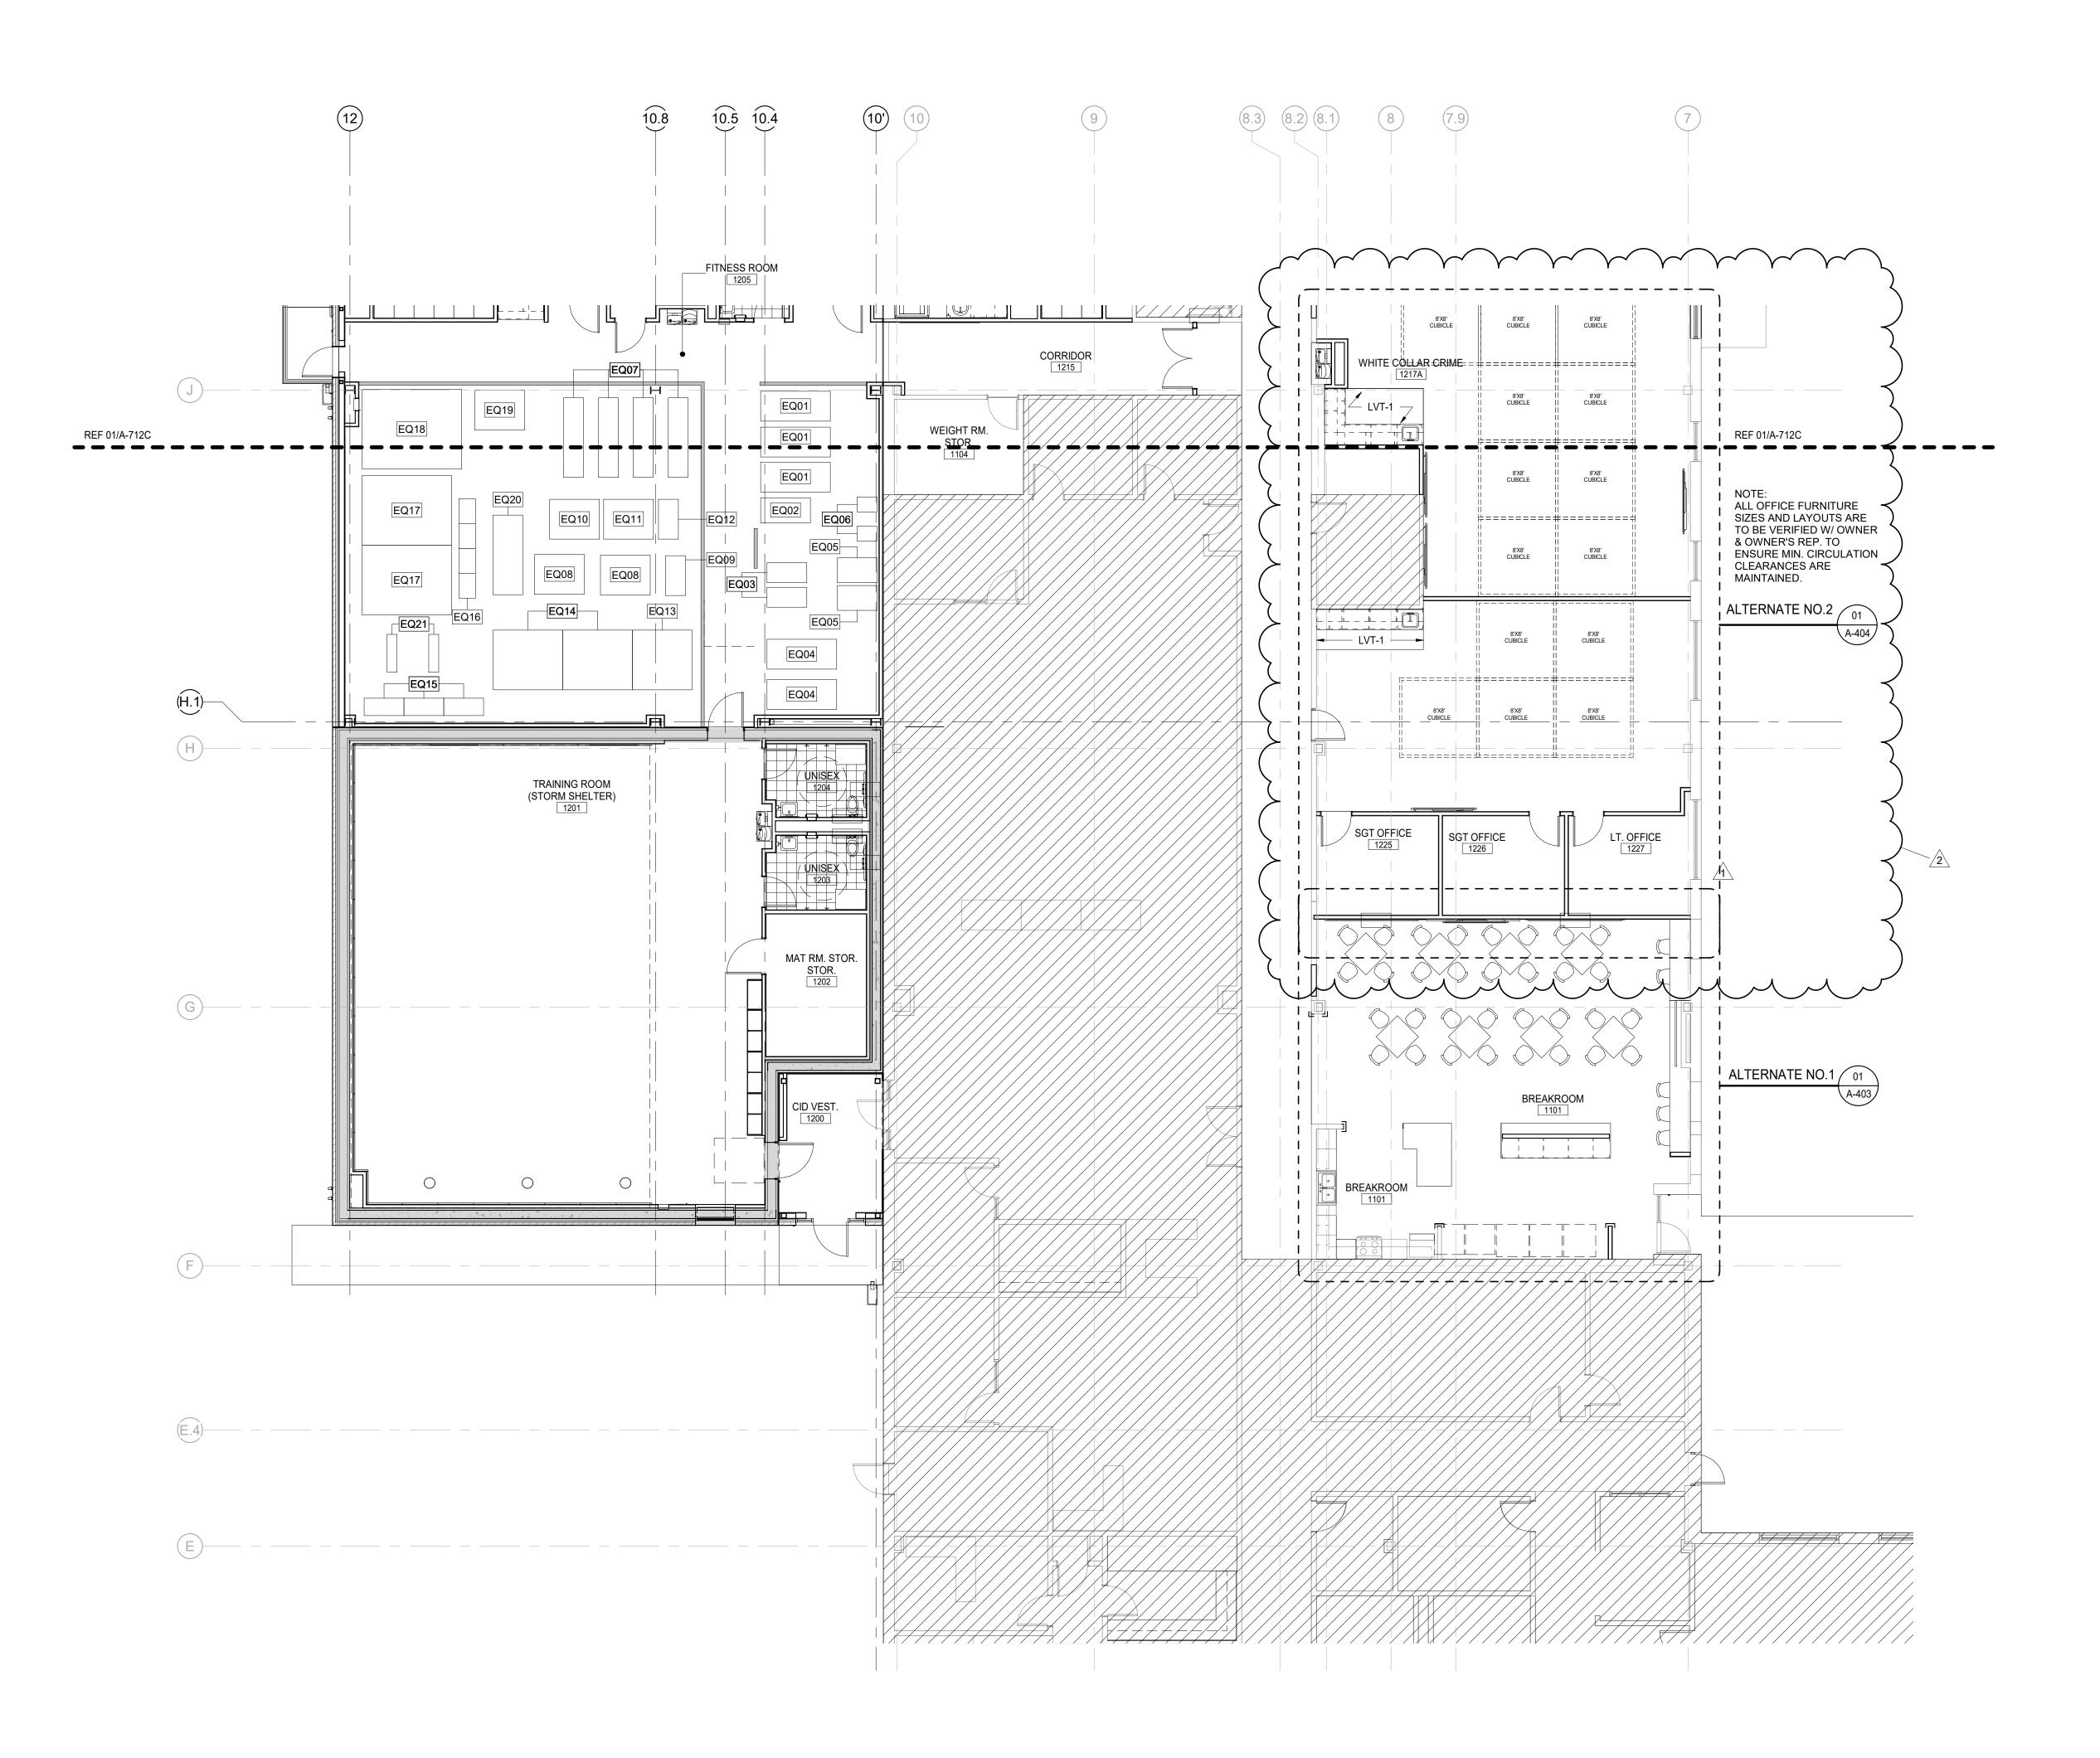
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20204.000 drawn by:

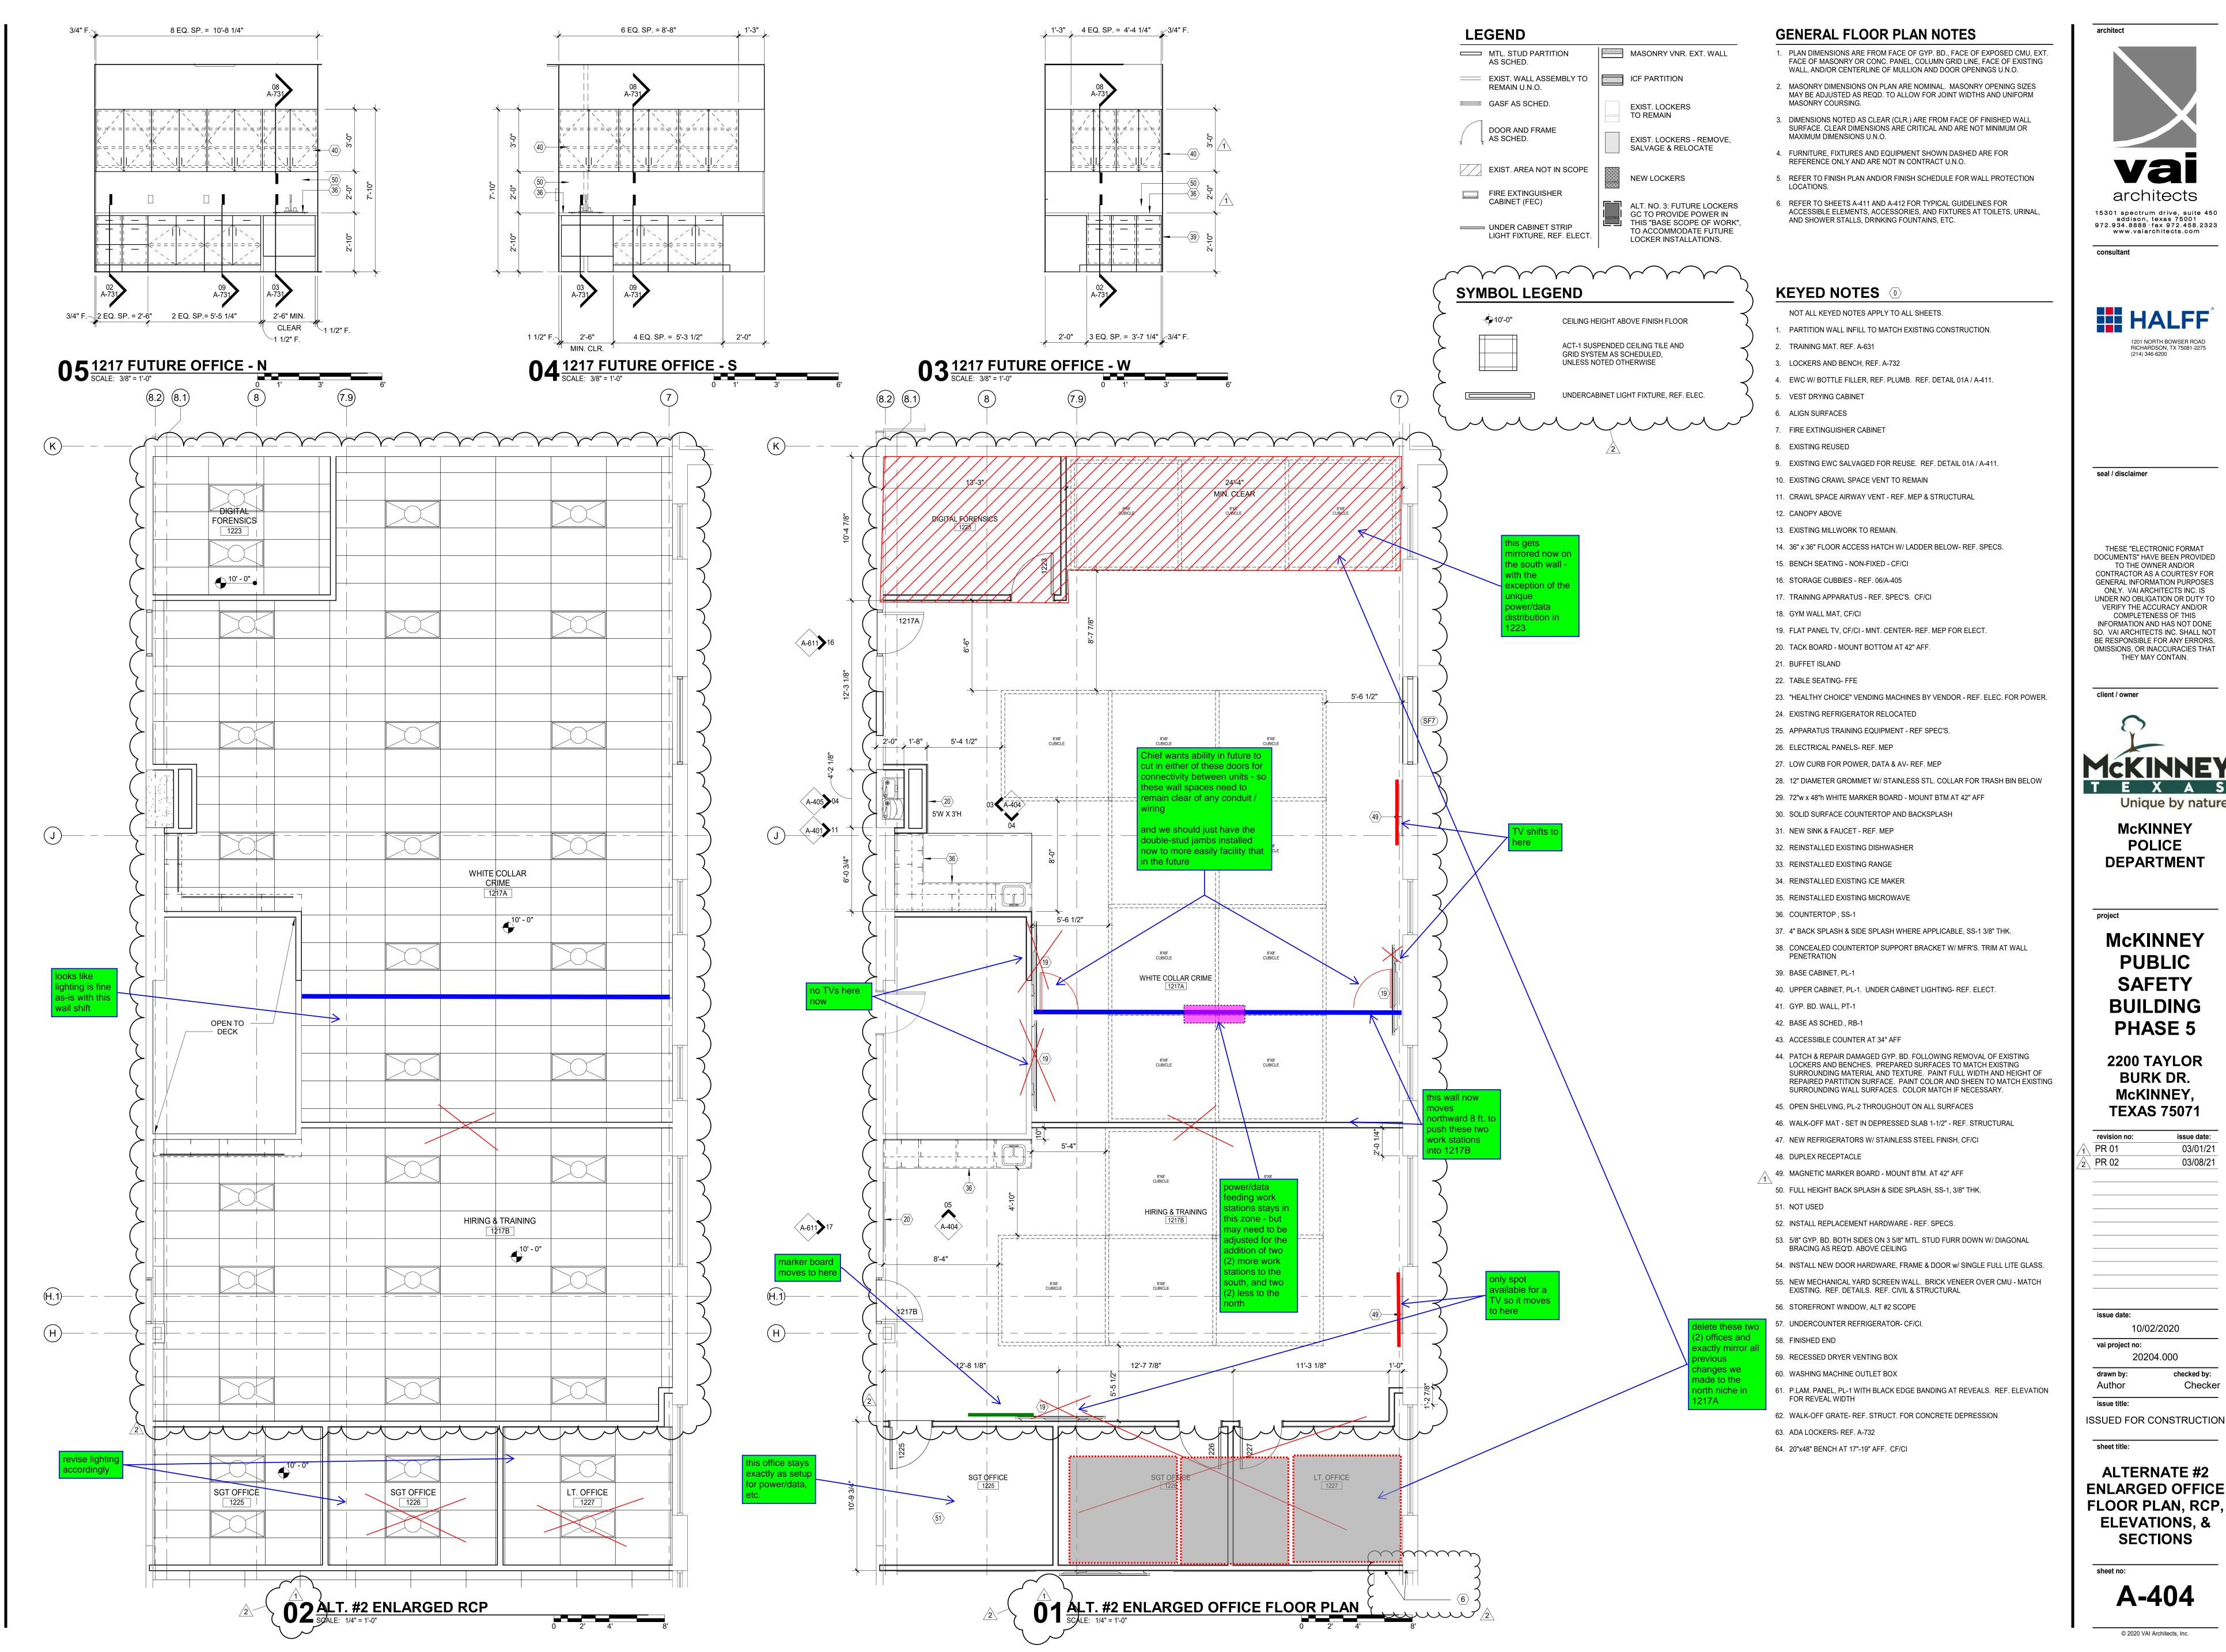Author Checker

ENLARGED OFFICE FLOOR PLAN, RCP, **ELEVATIONS, & SECTIONS**

A-404



1ST FLOOR FURNITURE &

O 1 EQUIPMENT PLAN - AREA B

SCALE: 1/8" = 1'-0"

TRUE
NORTH

O 4' 8' 16'

KEYED NOTES EQXX

NOTE: ALL FITNESS EQUIPMENT PROVIDED BY OWNER OR "OTHERS"

EQ01 TREADMILL

EQ02 STAIRMASTER

EQ03 STATIONARY BIKE

EQ04 ELLIPTICAL MACHINE

EQ05 ZERO GRAVITY

EQ06 UP-RIGHT SCALE

EQ07 ROW MACHINE

EQ08 SQUAT RACK (LARGE)

EQ09 SQUAT RACK (SMALL)
EQ10 LEG CURL

EQ11 LEG PRESS

EQ12 CALF MACHINE
EQ13 SMITH BENCH PRESS

EQ14 BENCH PRESS

EQ15 DUMBBELL RACK

EQ16 JUMP BOX

EQ17 LIFTING PLATFORM

EQ18 PULL UP / SQUAT SYSTEM 6-LEG

EQ19 PUNCHING BAG

EQ20 SAMSON TRAINER

EQ21 FUTURE FLAT BENCH

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PR 01 03/01/21
PR 02 03/08/21

10/02/202

20204.000 drawn by: checke

issue title:

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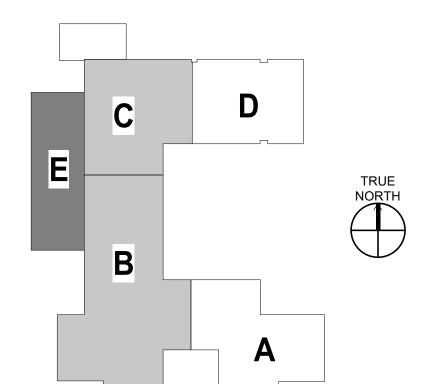
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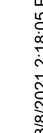
1ST FLOOR FURNITURE & EQUIPMENT PLAN -AREA B


A-712B

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KEY PLAN





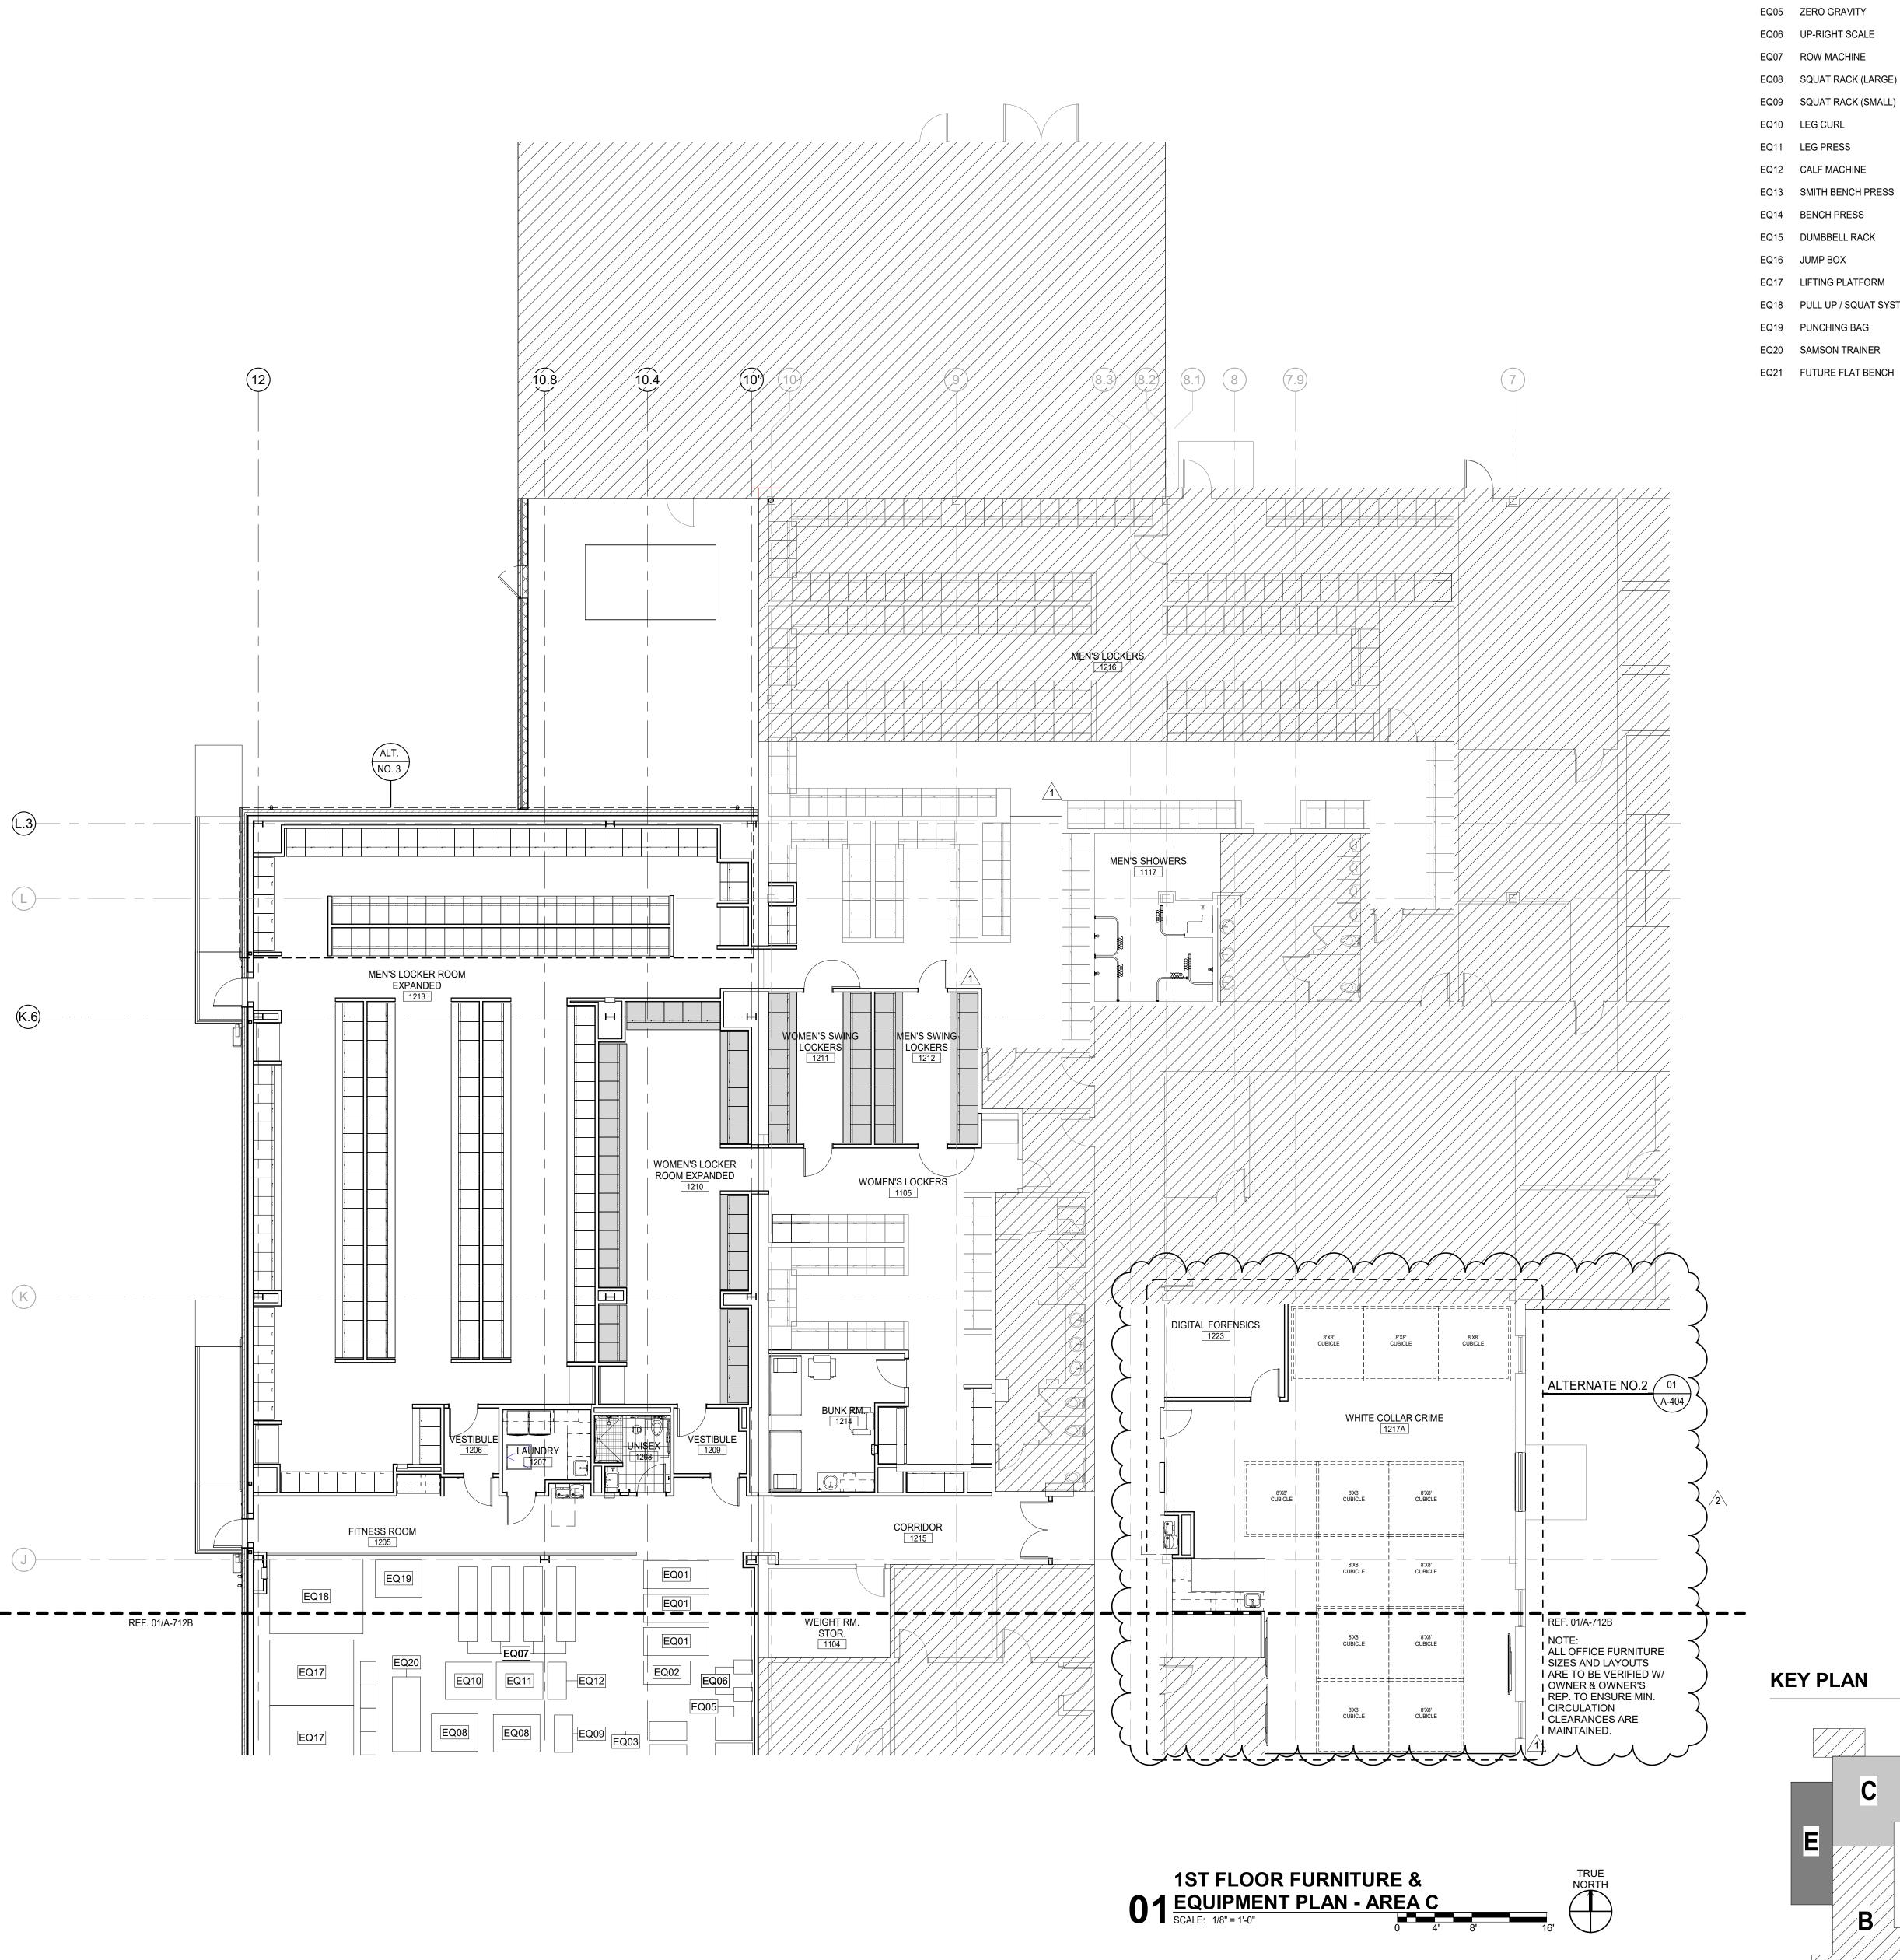

KEYED NOTES EQXX

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EQ01 TREADMILL

EQ02 STAIRMASTER

EQ03 STATIONARY BIKE

EQ04 ELLIPTICAL MACHINE

EQ05 ZERO GRAVITY

EQ06 UP-RIGHT SCALE

EQ08 SQUAT RACK (LARGE)

EQ11 LEG PRESS

EQ12 CALF MACHINE

EQ14 BENCH PRESS

EQ15 DUMBBELL RACK

EQ16 JUMP BOX

EQ18 PULL UP / SQUAT SYSTEM 6-LEG

EQ19 PUNCHING BAG

EQ21 FUTURE FLAT BENCH

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PR 02


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TRUE

1ST FLOOR FURNITURE & EQUIPMENT PLAN -AREA C

A-712C



1 HVAC PLAN - FIRST FLOOR - AREA B

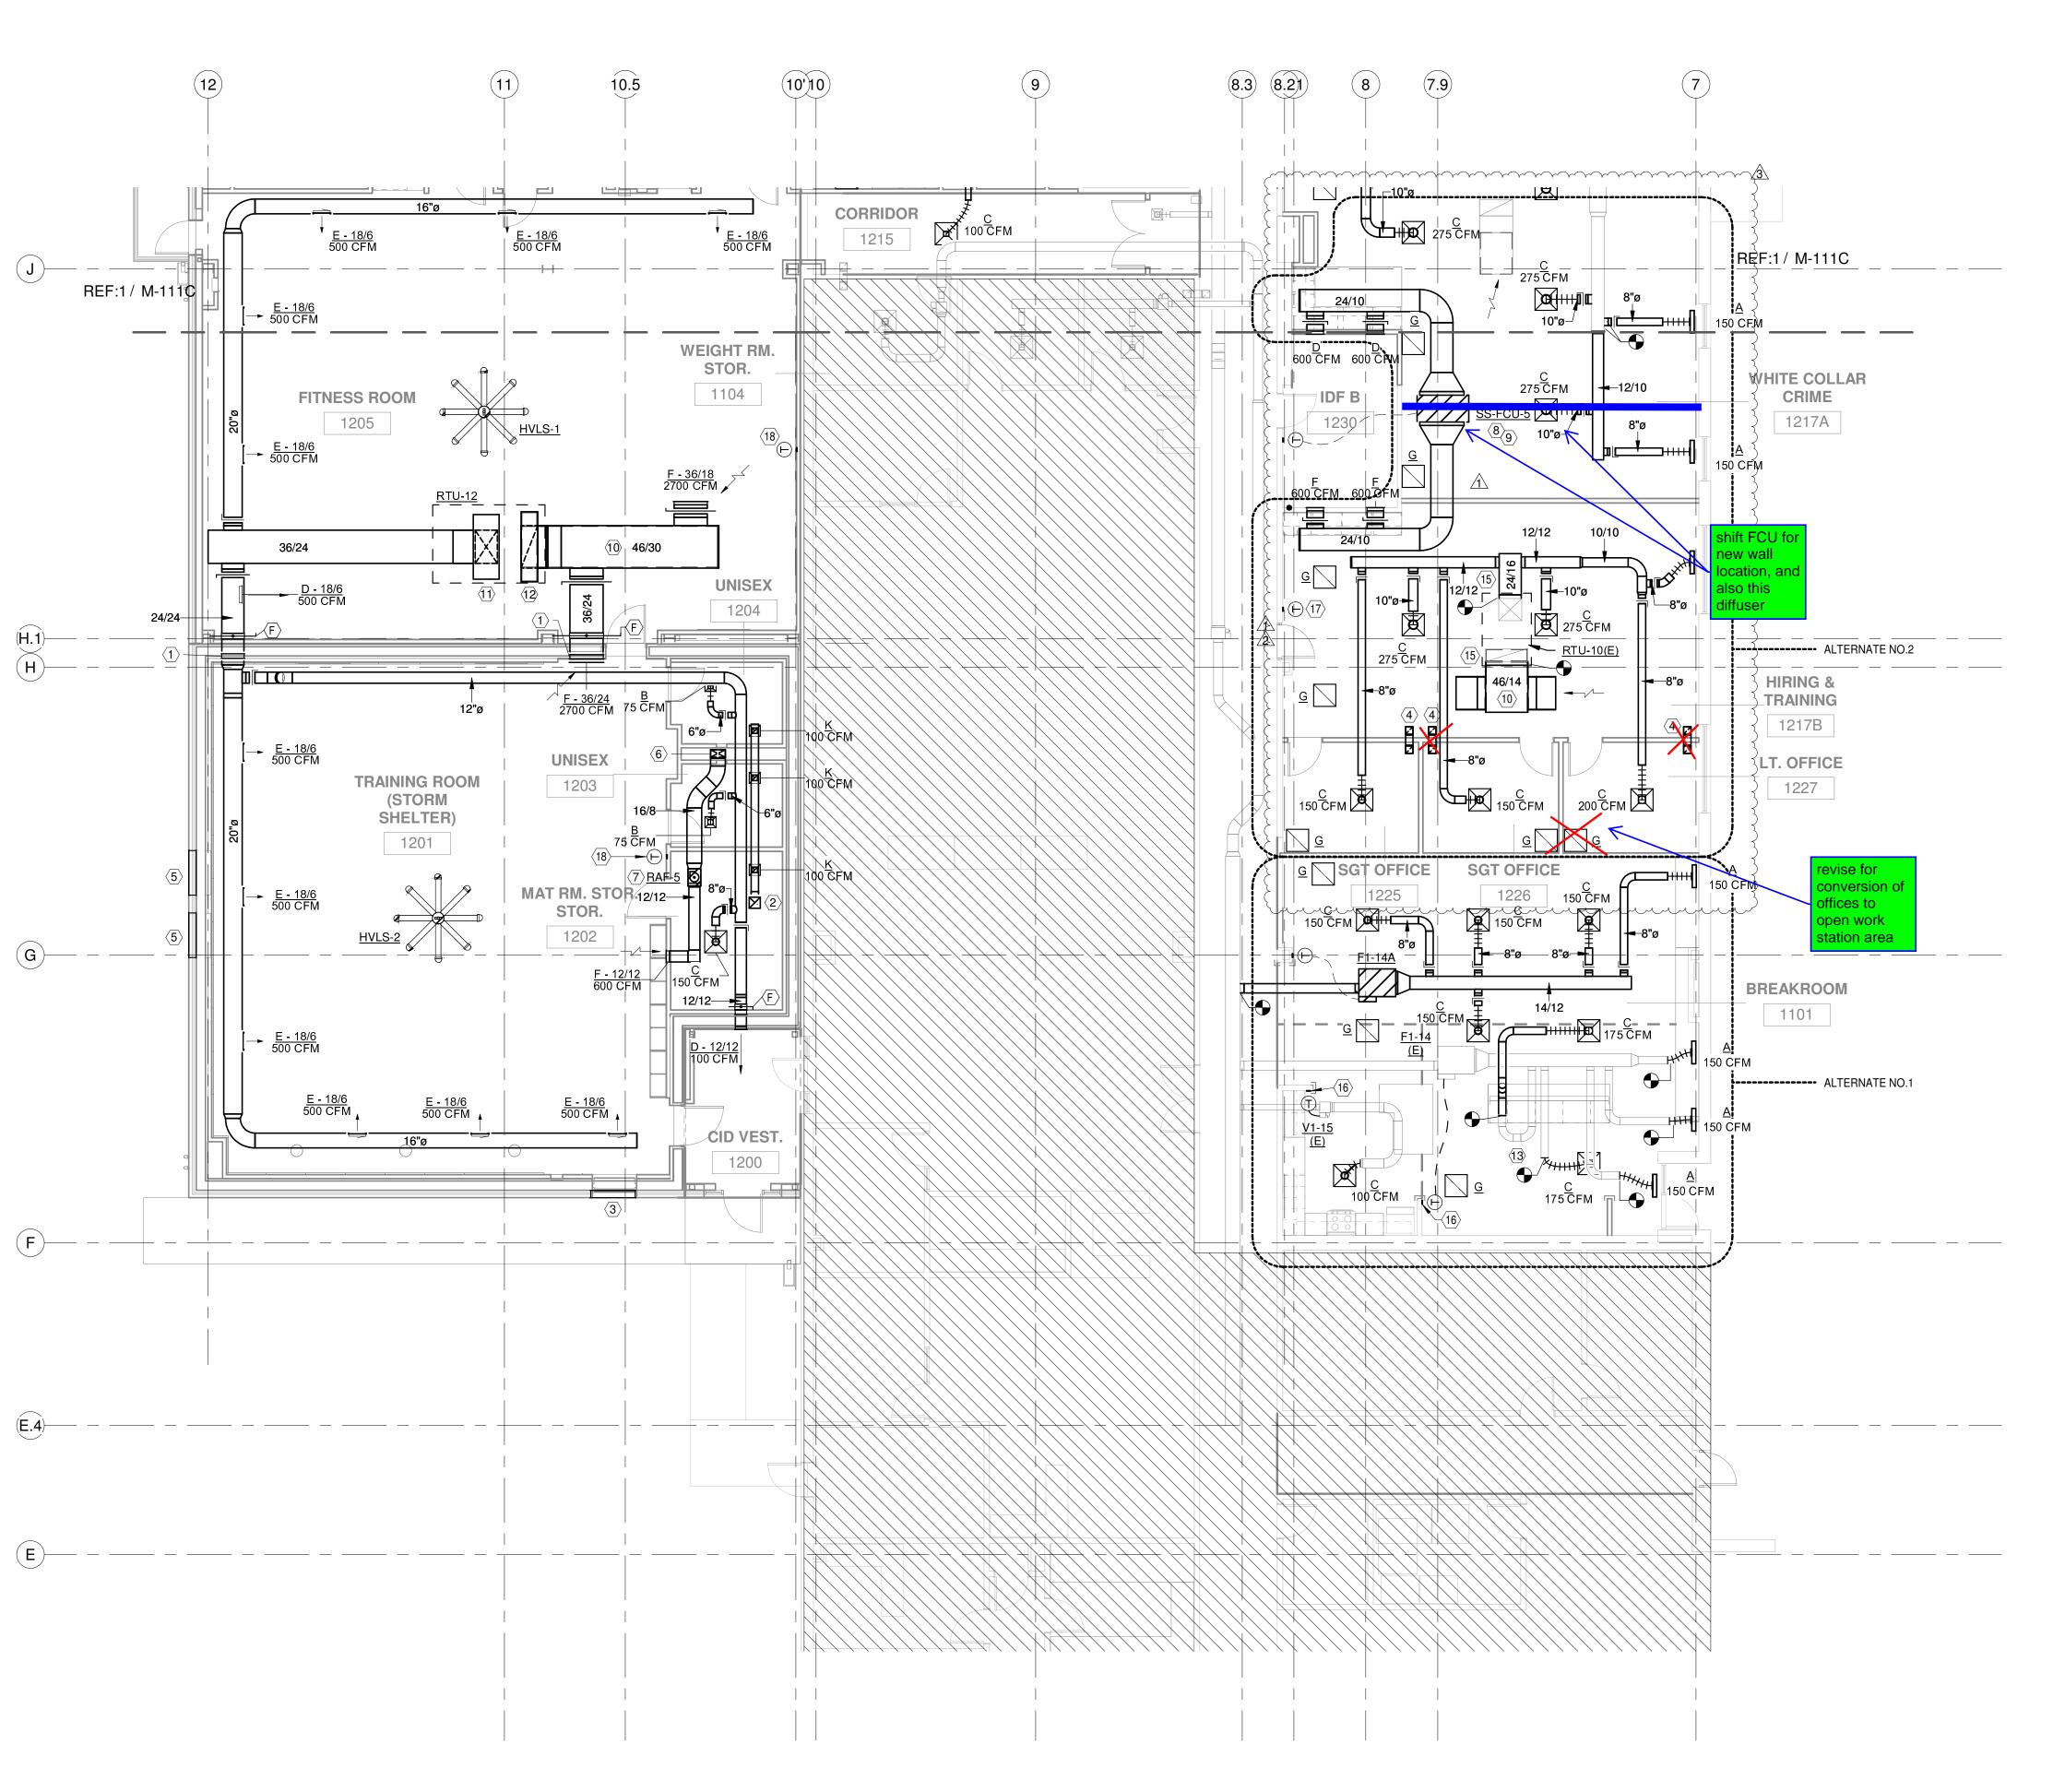SHEET NOTES

- IN ACCORDANCE WITH ICC 500-2014 SECTION 702.1.4, DUCT PENETRATION TO STORM SHELTER TO BE PROTECTED WITH ICC 500 RATED LOUVER INSTALLED IN DUCTWORK AT DEMISING WALL.
- 2 12/12 EXHAUST DUCT RISER TO EF-11. IN ACCORDANCE WITH ICC 500-2014 SECTION 702.1.4, PROTECT ROOF PENETRATION WITH ICC 500 RATED LOUVER INSTALLED IN DUCTWORK AT ROOF DECK.
- LOW POSITION STORM LOUVER AND INTERIOR COMBINATION LOUVER/DAMPER FOR SHUTOFF DURING NORMAL OPERATION. REFER TO LOUVER SCHEDULE AND M-112.
- 4 INSTALL 8/8 INSULATED TRANSFER BOOT AS HIGH AS POSSIBLE IN WALL. REFER TO DETAIL M-502/7.
- HIGH POSITION STORM LOUVER INSTALLED IN EXTERIOR WALL, MIN 120 IN A.F.F. REFER TO LOUVER SCHEDULE AND M-112.
- ROUTE DUCT DOWN IN PLUMBING CHASE TO CRAWLSPACE. LOCATE

BETWEEN LAVATORY AND WATER CLOSET CARRIERS.

- 7 SUPPPLY FAN RAF-5 TO INTERLOCK/RUN SIMULTANEOUSLY WITH RAF-4
- INSTALLED IN CRAWLSPACE BELOW.

INSTALL DUCTED MINISPLIT UNIT ABOVE CEILING IN ADJACENT SPACE AND

- ROUTE DUCTWORK TO SERVE IT EQUIPMENT. SUSPEND UNIT ALONG COLUMN LINES FOR SUPPORT BY STRUCTURAL.
- 9 ROUTE EVAPORATOR UNIT CONDENSATE TO NEAREST PLUMBING DRAIN. REFER TO PLUMBING PLANS.
- 10 PROVIDE INTERNALLY LINED RETURN AIR PLENUM AT UNIT RETURN CONNECTION. COVER WITH HARDWARE CLOTH ALL EXPOSED OPEN ENDS OF DUCT NOT PROTECTED BY AN AIR DEVICE.
- 11 36/24 SUPPLY DN FROM RTU-12. TRANSITION TO 70/28 IN ROOF CURB FOR UNIT CONNECTION.
- 12 46/24 RETURN UP TO RTU-12. TRANSITION TO 77/18 IN ROOF CURB FOR UNIT CONNECTION.
- 13 INSTALL NEW AIR DEVICES TO COORDINATE WITH UPDATED RCP.
 CONNECT TO EXISTING TAPS/DAMPERS. REBALANCE TO AIRFLOW SHOWN
 ON PLANS.
- 14 ALTERNATE #2: PROVIDE SPACE IN PR 02TH MANUAL DAMPER AND NOT USED REMOVED IN PR 02TH MANUAL DAMPER DEMICING WALL.
- 15 ALTERNATE #2: CONNECT NEW DUCTWORK TO EXISTING DUCT DROPS FROM RTU-10(E) . UTILIZE RADIUS ELBOWS TO MAKE VERTICAL TO HORIZONTAL TRANSITION.
- UPDATED FLOORPLAN.

ALTERNATE #1: RELOCATE EXISTING THERMOSTAT TO COORDINATE WITH

- 17 ALTERNATE #2: RELOCATE EXISTING THERMOSTAT TO COORDINATE WITH UPDATED FLOORPLAN.
- AVERAGING THERMOSTAT FOR ZONE SETPOINT POLLING AT RTU CONTROLLER. PROVIDE EQUAL VOTING POWER (PROGRAMMABLE) ACROSS ALL THERMOSTATS IN ZONE, TYPICAL TWO PER RTU.

KEY PLAN

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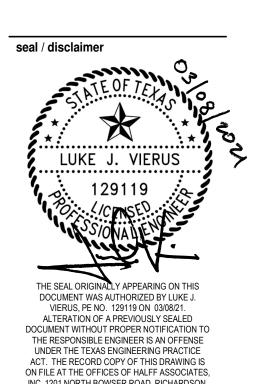
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revision no: issue date:
ADDENDUM #1 10/21/20
PR 01 03/01/21
PR 02 03/08/21

issue date:

issue date: 10/02/2020 vai project no:

drawn by: checked


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MECHANICAL HVAC PLAN - AREA B

M-111B

D20 VAI Architects Inc



1 HVAC PLAN - FIRST FLOOR - AREA C

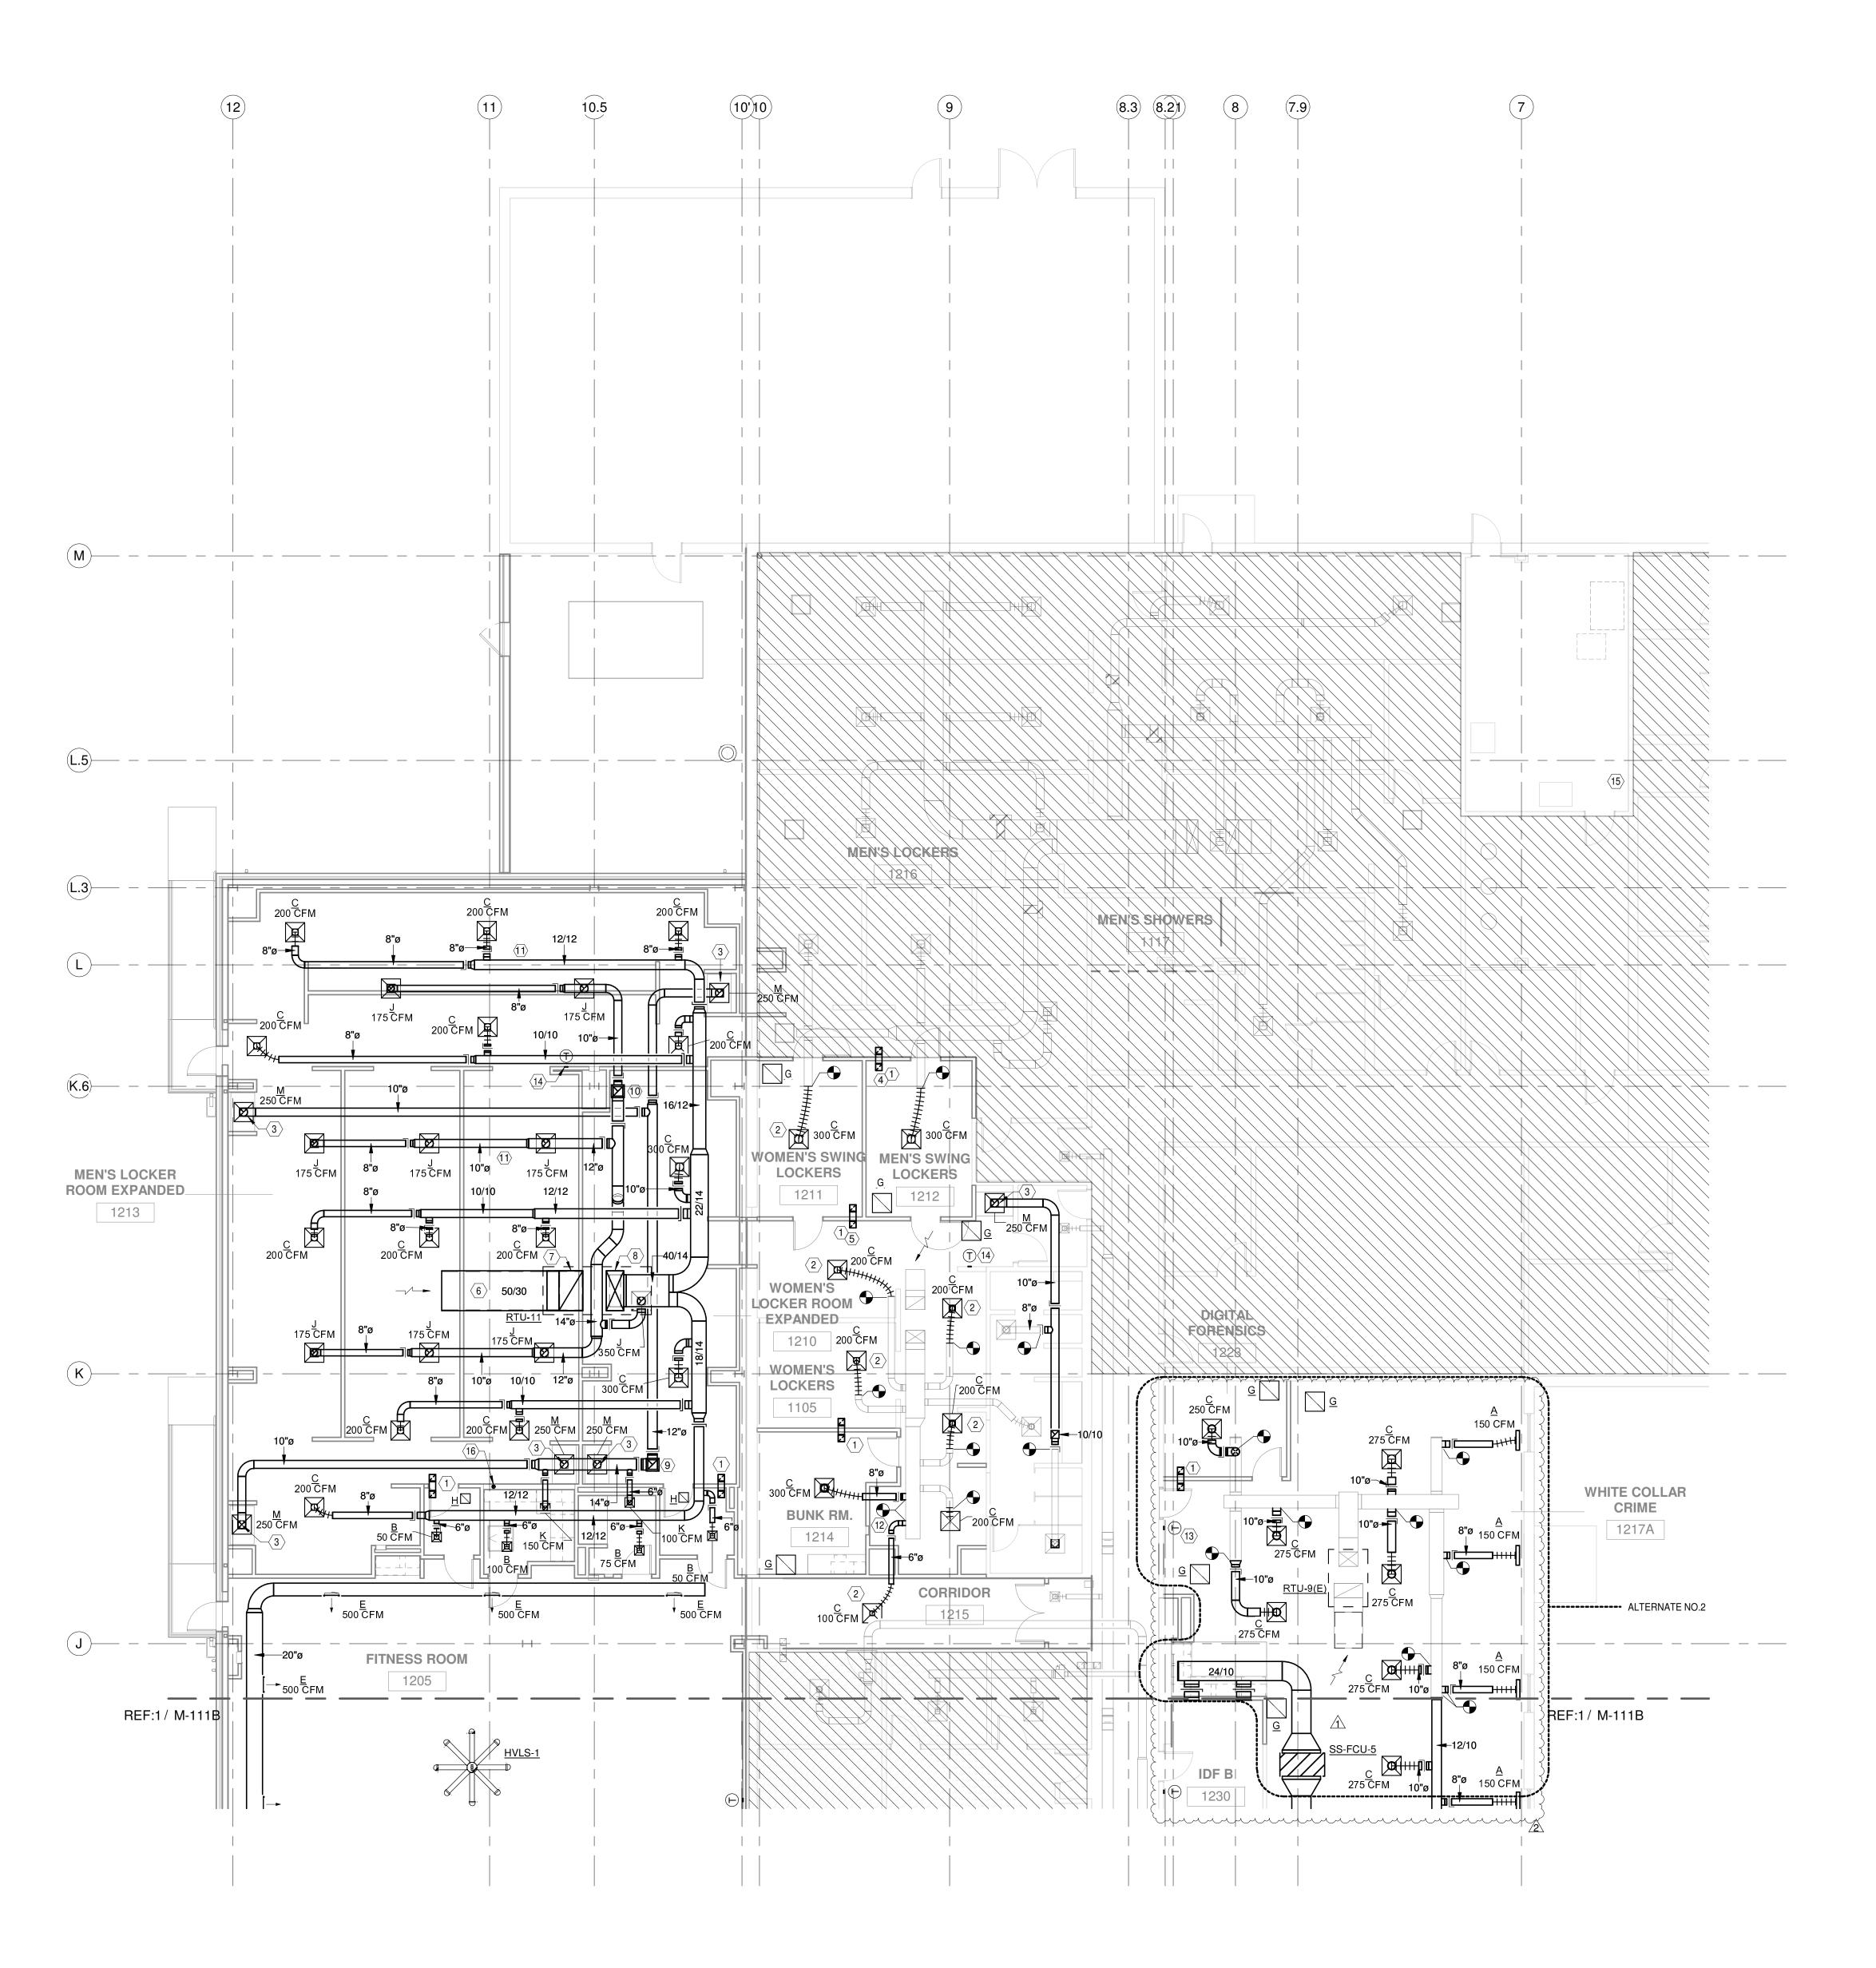SHEET NOTES

- INSTALL 8/8 INSULATED TRANSFER BOOT AS HIGH AS POSSIBLE IN WALL. REFER TO DETAIL M-502/7.
- INSTALL NEW AIR DEVICES TO COORDINATE WITH UPDATED RCP. CONNECT TO EXISTING TAPS/DAMPERS. REBALANCE TO AIRFLOW SHOWN ON PLANS.
- ROUTE 10" DUCT DOWN TO VEST DRYING CABINET AND BALANCE TO 250 CFM, AS SPECIFIED BY CLIENT. REFER TO ARCHITECTURAL PLANS FOR
- MEN'S SWING LOCKER TRANSFER BOOT TO TERMINATE IN PLENUM ABOVE MEN'S LOCKER.
- WOMEN'S SWING LOCKER TRANSFER BOOT TO TERMINATE IN PLENUM ABOVE WOMEN'S LOCKER.
- PROVIDE INTERNALLY LINED RETURN AIR PLENUM AT UNIT RETURN CONNECTION. COVER WITH HARDWARE CLOTH ALL EXPOSED OPEN ENDS OF DUCT NOT PROTECTED BY AN AIR DEVICE.
- 50/30 RETURN UP TO RTU-11.

CABINET DETAILS.


- 40/14 SUPPLY DN FROM RTU-11. TRANSITION TO 50/20 IN ROOF CURB FOR UNIT CONNECTION.
- 16/16 EXHAUST UP TO EF-13. TRANSITION TO 12/12 AT ROOF FOR CONNECTION TO FAN.
- 16/16 EXHAUST UP TO EF-12. TRANSITION TO 12/12 AT ROOF FOR CONNECTION TO FAN.
- ROUTE BRANCH DUCTWORK BETWEEN ROOF JOISTS RUNNING EAST/WEST, NORTH/SOUTH ORIENTED DUCT RUNOUTS LESS THAN 12" DIA. MAY BE ROUTED THRU JOIST WEBBING. TYPICAL OF ALL DUCTWORK WEST OF COLUMN LINE 10.5.
- REROUTE EXISTING DUCT RUNOUTS TO COORDINATE WITH NEW DEMISING WALLS.
- ALTERNATE #2: RELOCATE EXISTING THERMOSTAT TO COORDINATE WITH UPDATED FLOORPLAN.
- AVERAGING THERMOSTAT FOR ZONE SETPOINT POLLING AT RTU CONTROLLER. PROVIDE EQUAL VOTING POWER (PROGRAMMABLE) ACROSS ALL THERMOSTATS IN ZONE, TYPICAL TWO PER RTU.
- PROVIDE 120 VAC SERVICE FOR NEW HVAC CONTROLS PANEL, BY CONTROLS CONTRACTOR. PANEL TO BE INSTALLED ADJACENT TO EXISTING CONTROL PANEL.
- 4" VERTICAL DRYER VENT. ROUTE UP IN STUD WALL TO TERMINATE ABOVE ROOF IN GOOSENECK FITTING. PROVIDE BACKDRAFT DAMPER AND MEANS FOR REGULAR CLEANOUT.



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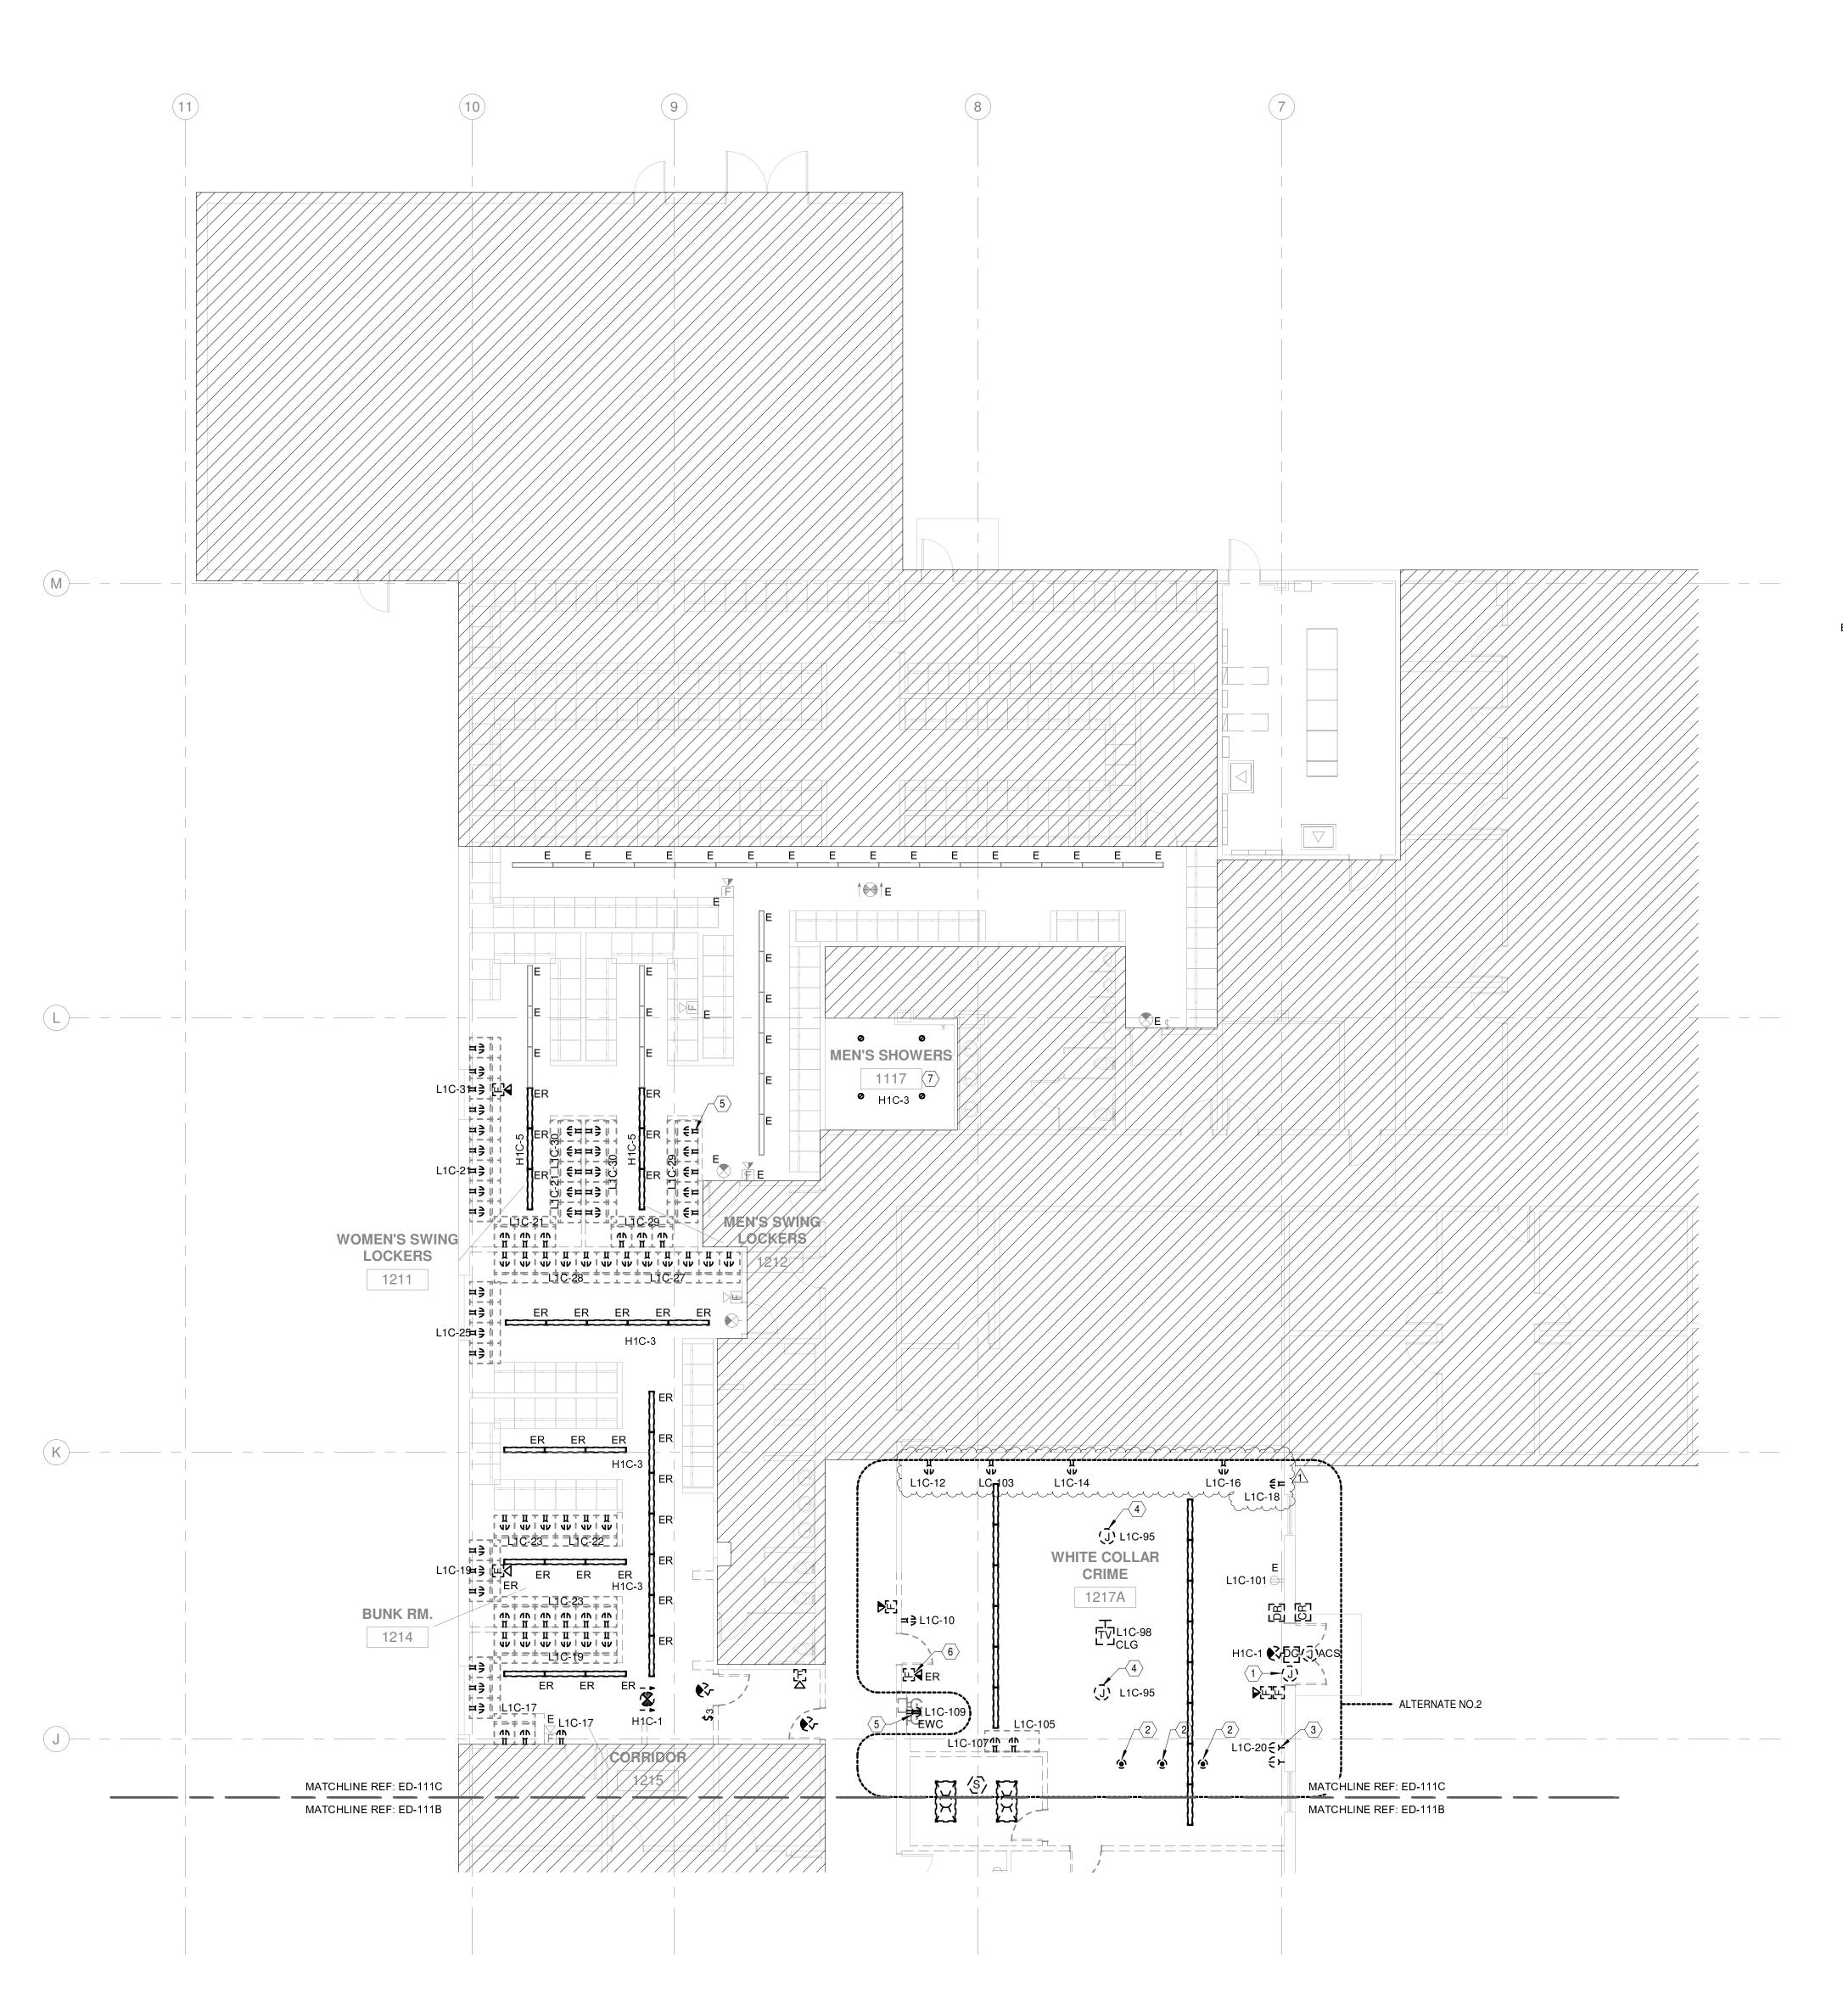
↑ ADDENDUM #1

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MECHANICAL HVAC PLAN - AREA C

M-111C

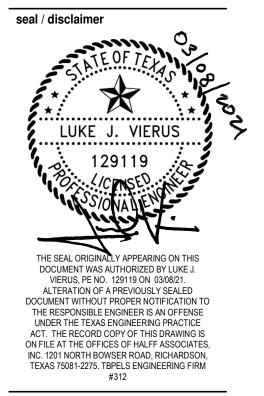KEY PLAN



- A. REFER TO SHEET EG-001 FOR GENERAL NOTES AND LEGEND.
- B. FIELD VERIFY EXACT LOCATION OF ALL EXISTING EQUIPMENT TO REMAIN AND TO BE DEMOLISHED.
- C. ALL EXISTING FIRE AND SECURITY EQUIPMENT TO REMAIN UNLESS NOTIFIED OTHERWISE.
- D. ALL DASHED DEVICES TO BE DEMOLISHED. ALL CONDUIT, CONDUCTOR, AND ASSOCIATED COMPONENTS TO BE REMOVED BACK
- SUBSCRIPT: E = EXISTING TO REMAIN R = RELOCATED ER = EXISTING TO BE RELOCATED.

EC = EXISTING TO REMAIN, CEILING MOUNT.





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SHEET NOTES

- EXISTING ELECTRONIC DOOR STATUS INDICATOR TO BE DEMOLISHED. ALL EQUIPMENT, CONDUIT AND CONDUCTOR TO BE REMOVED BACK TO SOURCE. FIELD VERIFY EXACT LOCATION.
- REMOVE AND DEMOLISH EXISTING FLOOR BOX. FILL WITH CONCRETE LEVEL WITH FINISHED FLOOR PER DIVISION 03 SPECIFICATIONS.
- EXISTING SIMPLEX RECEPTACLE TO BE REMOVED AND DEMOLISHED
- DEMOLISH EXISTING FAN. PRESERVE CONDUCTORS IN NEAREST JUNCTION BOX FOR REUSE.

ABOVE CEILING FOR LATER REUSE.

- EXISTING DUPLEX RECEPTACLE TO BE REMOVED AND DEMOLISHED. REMOVE CONDUIT. PRESERVE CONDUCTORS IN NEAREST JUNCTION BOX
- EXISTING FIRE ALARM DEVICE TO BE REMOVED AND PRESERVED FOR REUSE. PRESERVE WIRING IN NEAREST JUNCTION BOX FOR REUSE. TYPICAL UNLESS NOTED OTHERWISE.
- EXISTING LIGHT FIXTURE TO BE REMOVED AND DEMOLISHED. PRESERVE CONDUCTORS AND CONTROL WIRING IN NEAREST JUNCTION BOX FOR REUSE. TYPICAL UNLESS NOTED OTHERWISE.

KEY PLAN

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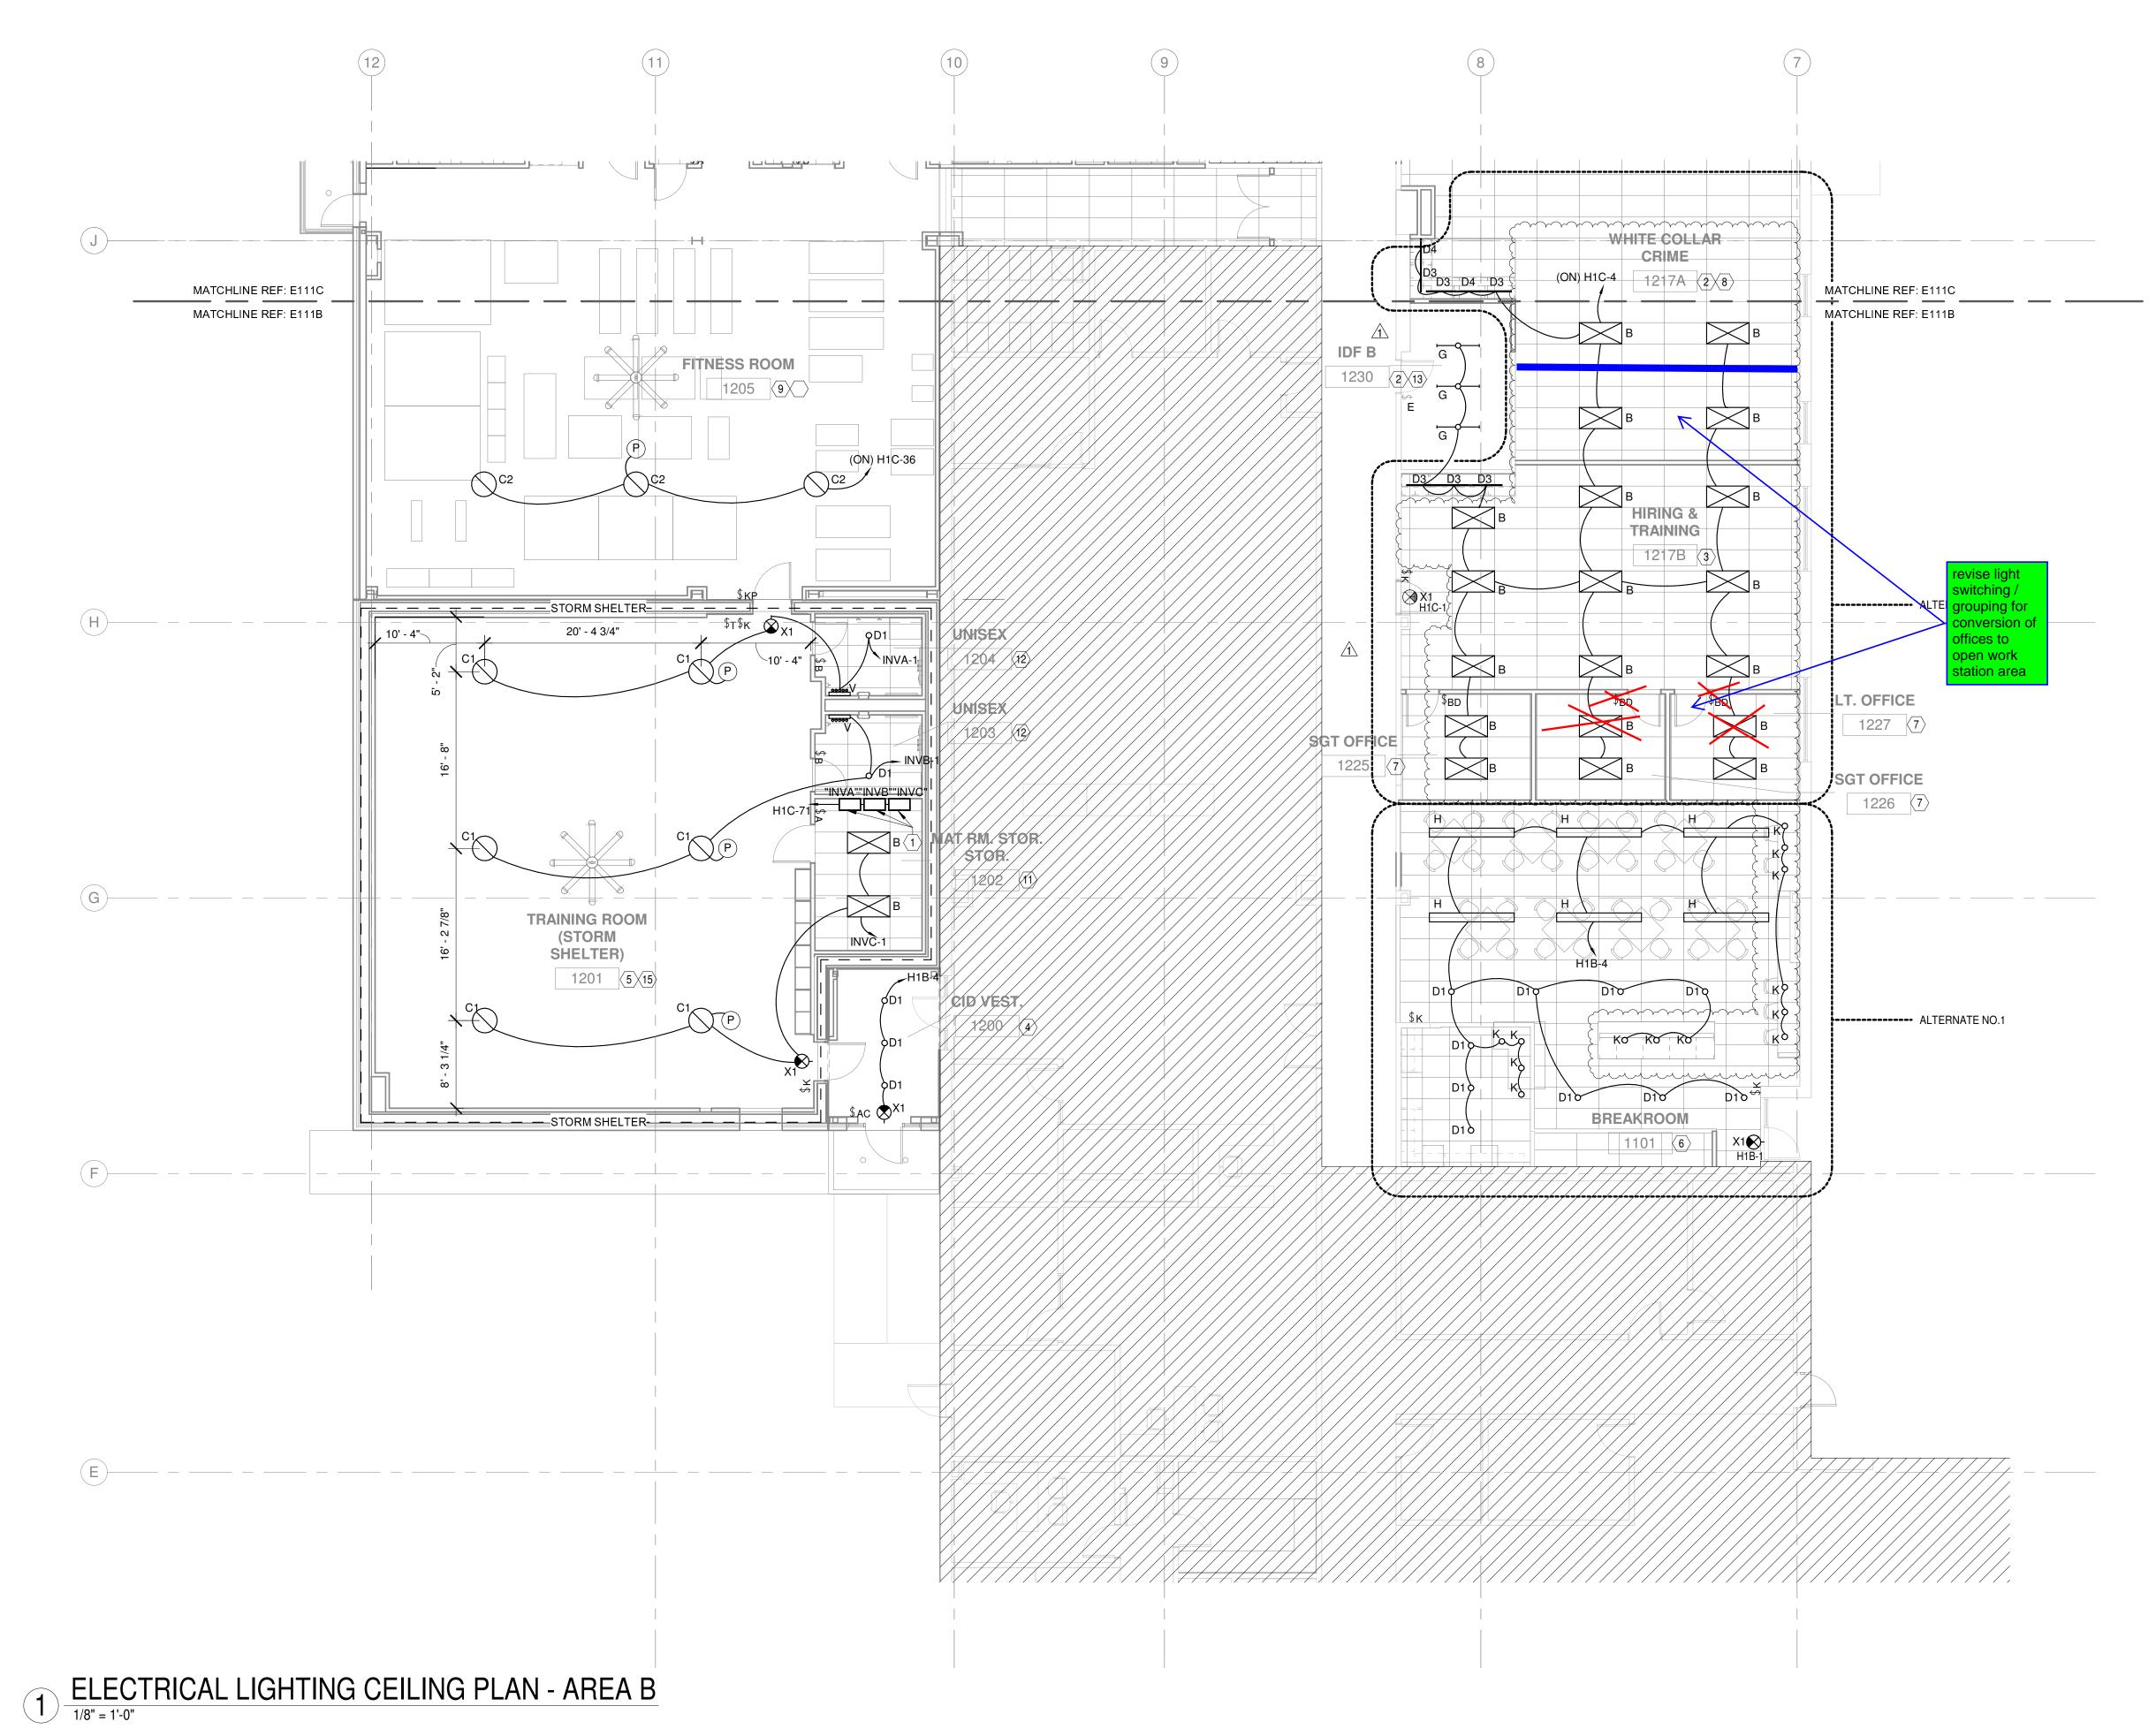
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ELECTRICAL DEMOLITION PLAN -AREA C

ED-111C

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1 ELECTRICAL DEMOLITION POWER PLAN - AREA C



- DAYLIGHTING CONTROL A. DAYLIGHTING CONTROLS SHALL COMPLY WITH IECC 2015 SECTIONS
- C405.2.3 AND C405.2.5 B. WHEREVER SIDELIGHTING (WINDOWS) EXIST, DAYLIGHTING CONTROLS WILL BE REQUIRED EXCEPT WHEN THE TOTAL LIGHTING POWER OF

THE DAYLIGHTING ZONE IS 150VA OR LESS, OR WHEN THE TOTAL


- GLAZING AREA IS 24 SF OR LESS. THE DAYLIGHTING ZONE SHALL BE DEFINED AS THE WIDTH OF THE WINDOW PLUS 2 FEET ON EITHER SIDE OF THE WINDOW AND WILL
- EXTEND THE DISTANCE OF THE HEAD HEIGHT OF THE WINDOW. A DAYLIGHTING SENSOR SHALL BE PROVIDED TO ADJUST THE LIGHTING (LUMENS) IN RESPONSE TO AVAILABLE DAYLIGHT. THE LIGHTING RESPONSE TO THE PRESENCES OF DAYLIGHT SHALL DIM THE ROOM LIGHTS TO ACHIEVE A MINIMUM ILLUMINATION LEVEL.
- A. PRIVATE OFFICES (<300 SF) AND STORAGE ROOMS SHALL HAVE: A) CONTROLS FOR MANUAL ON AND FULL OFF, AND B) OCCUPANCY
- RESTROOMS SHALL HAVE: A) CONTROLS FOR FULL ON AND FULL OFF, AND B) OCCUPANCY SENSOR.
- OFF, AND B) OCCUPANCY SENSOR. WEIGHT ROOM AND MAT ROOM SHALL HAVE: A) CONTROLS FOR

- A. REFER TO EG-001 FOR GENERAL NOTES AND LEGEND. B. FIXTURE TYPE:
- E = EXISTING TO REMAIN R = RELOCATED

- EXTEND EXISTING LIGHTING CIRCUITS IN EXISTING ROOM AS SHOWN TO
- REFER TO LIGHTING CONTROL DETAIL E-502/12 FOR HIRING & TRAINING,
- REFER TO LIGHTING CONTROL DETAIL E-502/2 FOR CID VESTIBULE, TYPICAL.
- REFER TO LIGHTING CONTROL DETAIL E-502/8 FOR TRAINING ROOM / STORM SHELTER, 1201.
- REFER TO LIGHTING CONTROL DETAIL E-502/11 FOR BREAKROOM, 1101.
- REFER TO LIGHTING CONTROL DETAIL E-502/1 FOR PRIVATE OFFICE,
- REFER TO LIGHTING CONTROL DETAIL E-502/6 FOR WHITE COLLAR CRIME, 1217A.
- REFER TO LIGHTING CONTROL DETAIL E-502/9 FOR FITNESS ROOM, 1205.
- REFER TO LIGHTING CONTROL DETAIL E-502/4 FOR LAUNDRY ROOM,
- REFER TO LIGHTING CONTROL DETAIL E-502/3 FOR RESTROOM,
- EXISTING LIGHTING TO REMAIN. EXTEND EXISTING LIGHTING CONTROL CIRCUIT TO NEW LIGHT FIXTURE.
- TYPE 'C1' FIXTURE TO BE SURFACE MOUNTED TO CENTER OF THE STRUCTURAL W FLANGE. DIMENSIONS ARE APPROXIMATE. FIELD VERIFY

SHEET NOTES NOT USED:

KEY PLAN

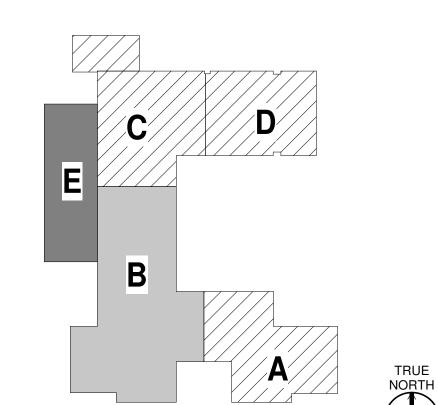

ELECTRICAL LIGHTING CEILING

vai project no:

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PLAN - AREA B

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ROOM LIGHTING CONTROL

OPEN OFFICES (>300 SF) SHALL HAVE: A) CONTROLS SCENE CONTROL B) OCCUPANCY SENSOR, C) ABILITY FOR PARTIAL ON, AND D) FULL

D. BREAK ROOM SHALL HAVE: A) CONTROLS FOR MANUAL ON AND FULL

MANUAL ON AND FULL OFF, AND B) OCCUPANCY SENSOR.

ER = EXISTING TO BE RELOCATED.SHEET NOTES LOCATED NEXT TO ROOM NAME / ROOM NUMBERS DEFINE REQUIREMENTS FOR THE ROOM.

SHEET NOTES

PROVIDE 277V, SINGLE PHASE, 1000 VA LIGHTING INVERTER WITH WALL MOUNTING BRACKET FOR STORM SHELTER LIGHTING. MOUNT 6' AFF. EQUAL TO LM-1000-1P-IB-OB-C(1)-WM. REFER TO INVERTER EMERGENCY LIGHTING CALCULATIONS ON E-601.


NEW OR RELOCATED LIGHT FIXTURES IN THIS ROOM AS SHOWN.


10 NOT USED.

mmmm

EXACT LOCATION OF W FLANGES.

NOT USED.

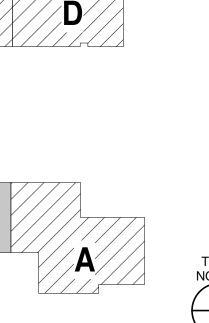

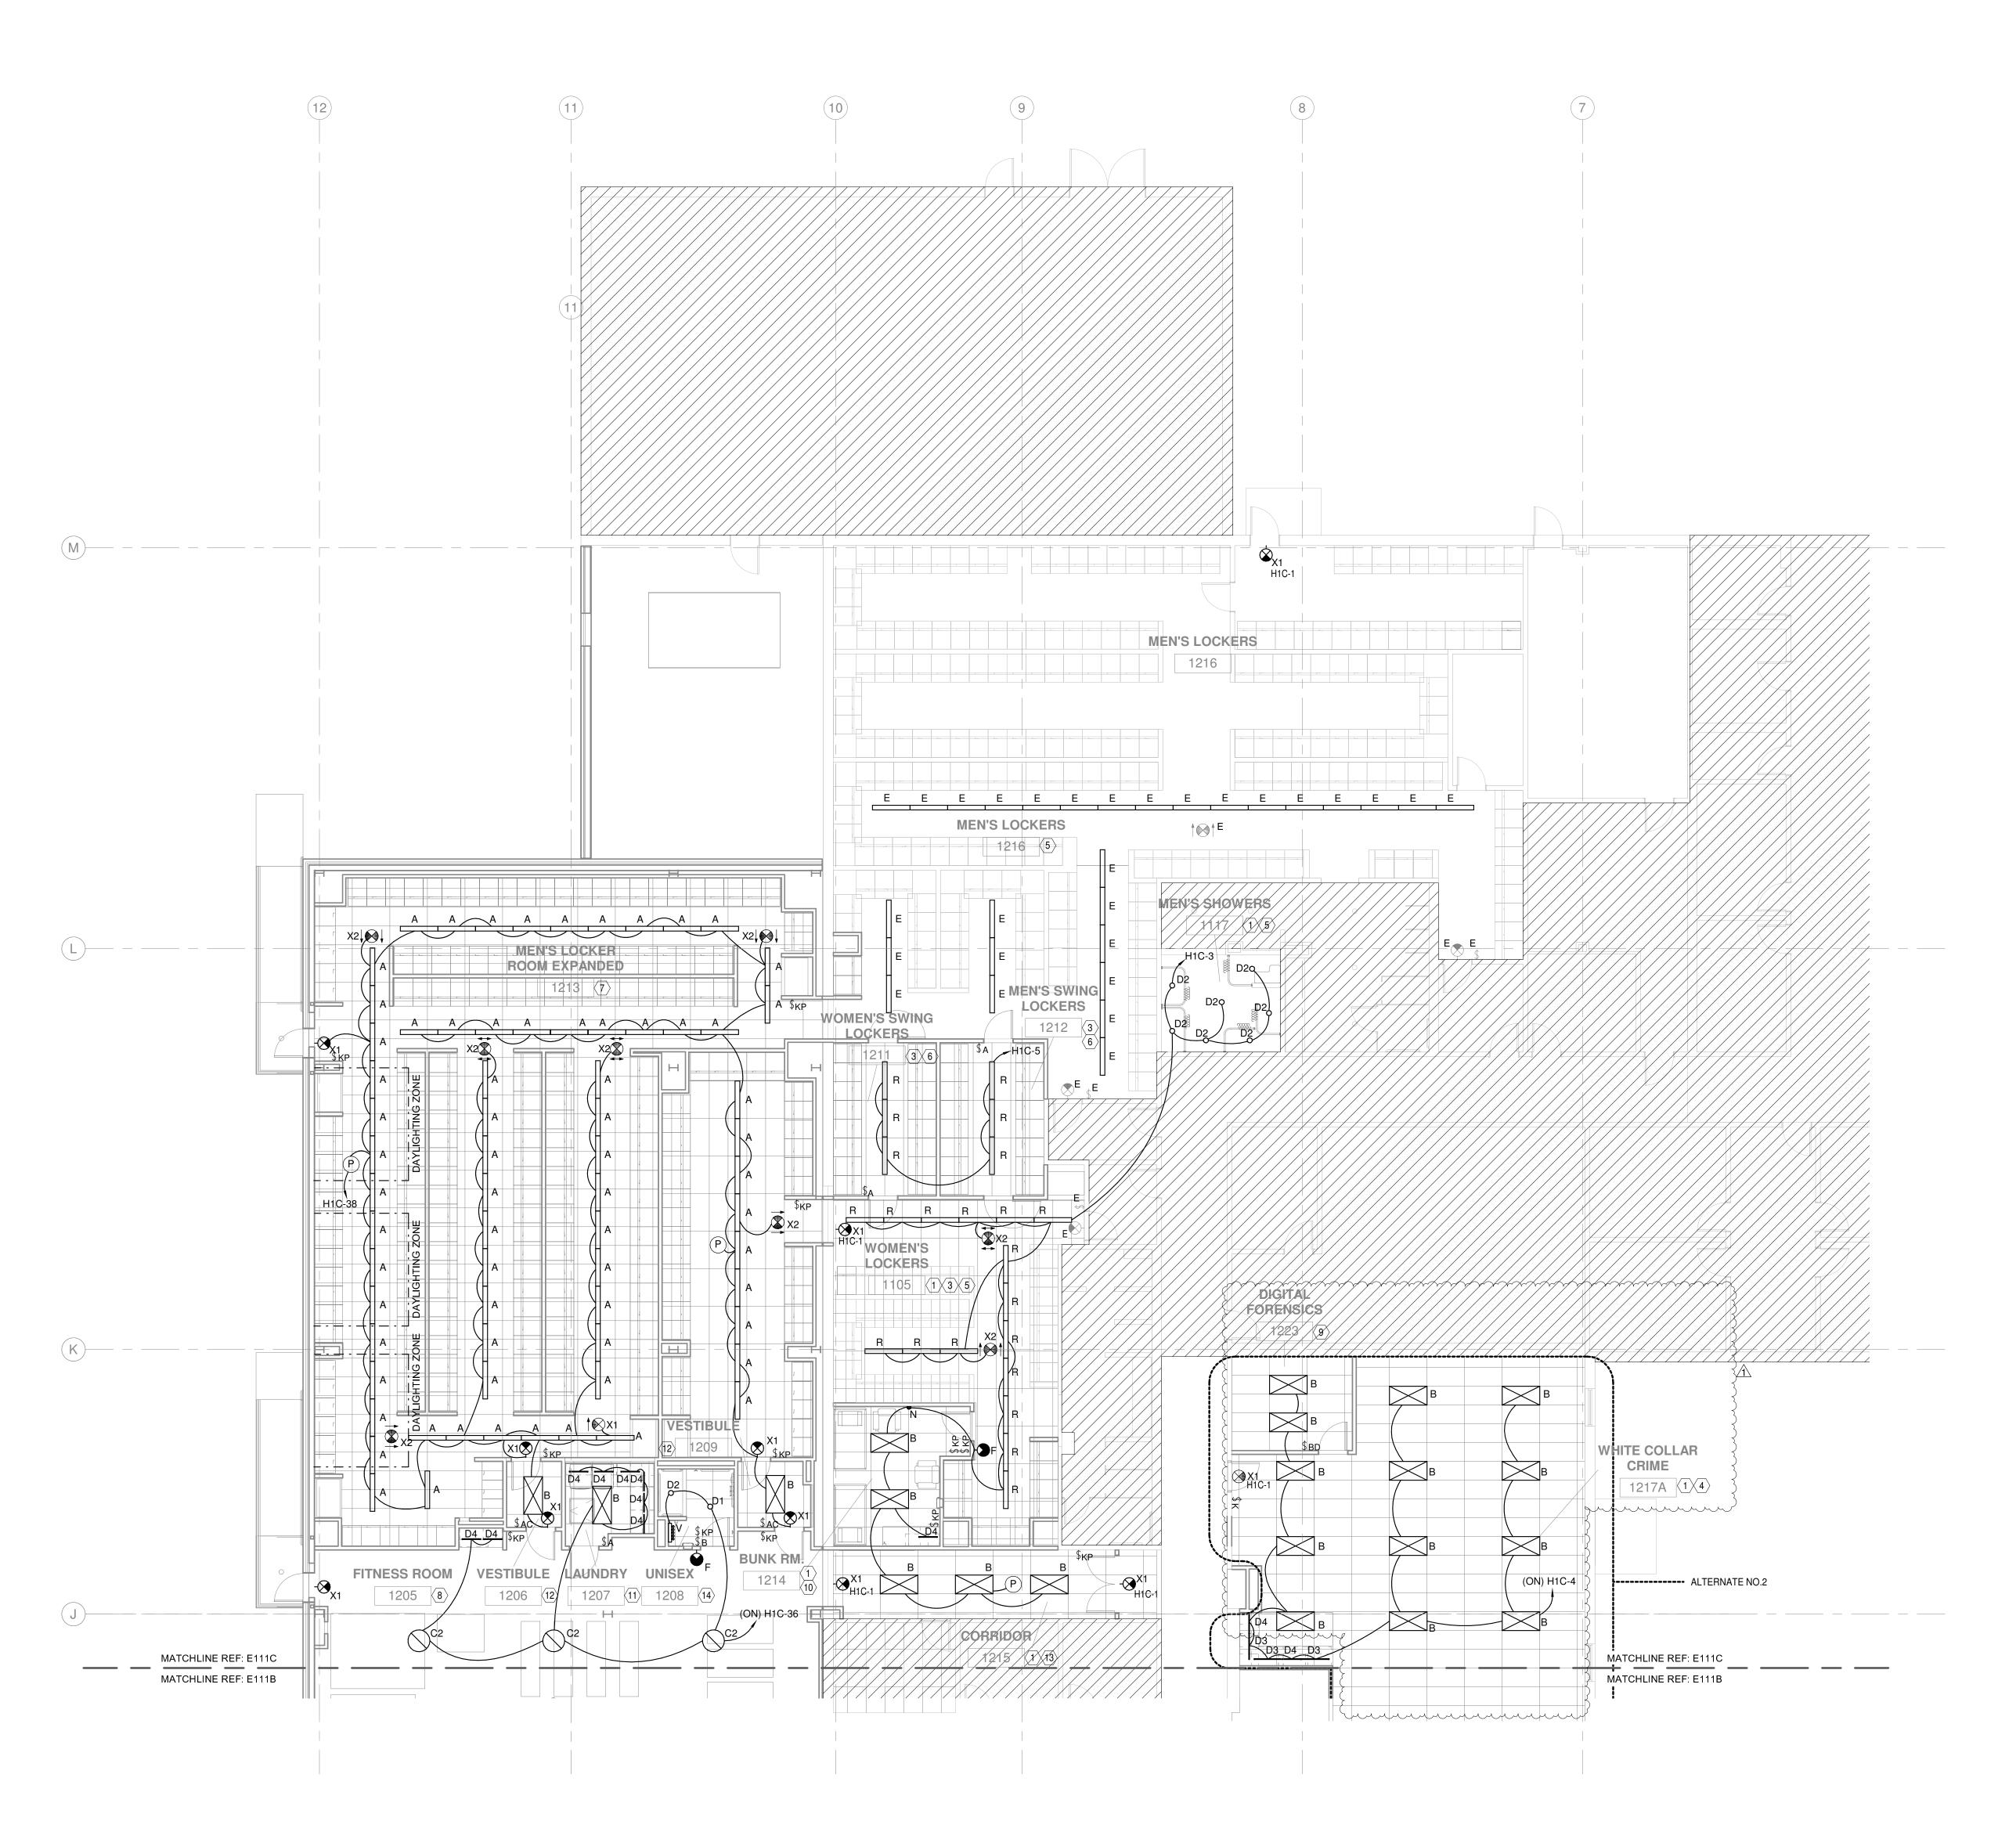

1 ELECTRICAL LIGHTING CEILING PLAN - AREA C

GENERAL NOTES

- DAYLIGHTING CONTROL A. DAYLIGHTING CONTROLS SHALL COMPLY WITH IECC 2015 SECTIONS
- C405.2.3 AND C405.2.5 B. WHEREVER SIDELIGHTING (WINDOWS) EXIST, DAYLIGHTING CONTROLS WILL BE REQUIRED EXCEPT WHEN THE TOTAL LIGHTING POWER OF THE DAYLIGHTING ZONE IS 150VA OR LESS, OR WHEN THE TOTAL
- GLAZING AREA IS 24 SF OR LESS. THE DAYLIGHTING ZONE SHALL BE DEFINED AS THE WIDTH OF THE WINDOW PLUS 2 FEET ON EITHER SIDE OF THE WINDOW AND WILL EXTEND THE DISTANCE OF THE HEAD HEIGHT OF THE WINDOW.
- A DAYLIGHTING SENSOR SHALL BE PROVIDED TO ADJUST THE LIGHTING (LUMENS) IN RESPONSE TO AVAILABLE DAYLIGHT. THE LIGHTING RESPONSE TO THE PRESENCES OF DAYLIGHT SHALL DIM THE ROOM LIGHTS TO ACHIEVE A MINIMUM ILLUMINATION LEVEL.

- ROOM LIGHTING CONTROL A. PRIVATE OFFICES (<300 SF) AND STORAGE ROOMS SHALL HAVE: A) CONTROLS FOR MANUAL ON AND FULL OFF, AND B) OCCUPANCY
- RESTROOMS SHALL HAVE: A) CONTROLS FOR FULL ON AND FULL OFF, AND B) OCCUPANCY SENSOR. OPEN OFFICES (>300 SF) SHALL HAVE: A) CONTROLS SCENE CONTROL,
- B) OCCUPANCY SENSOR, C) ABILITY FOR PARTIAL ON, AND D) FULL BREAK ROOM SHALL HAVE: A) CONTROLS FOR MANUAL ON AND FULL
- OFF, AND B) OCCUPANCY SENSOR. WEIGHT ROOM AND MAT ROOM SHALL HAVE: A) CONTROLS FOR MANUAL ON AND FULL OFF, AND B) OCCUPANCY SENSOR.

GENERAL:

A. REFER TO EG-001 FOR GENERAL NOTES AND LEGEND. B. FIXTURE TYPE:

ER = EXISTING TO BE RELOCATED.

- E = EXISTING TO REMAIN R = RELOCATED
- SHEET NOTES LOCATED NEXT TO ROOM NAME / ROOM NUMBERS DEFINE REQUIREMENTS FOR THE ROOM.


SHEET NOTES

- EXTEND EXISTING LIGHTING CIRCUITS IN EXISTING ROOM AS SHOWN TO NEW OR RELOCATED LIGHT FIXTURES IN THIS ROOM AS SHOWN.
- NOT USED. www.
- DETERMINE THE HIGHEST QUALITY STORED LOCKER ROOM LIGHT FIXTURES OF THE QUANTITY SHOWN. REINSTALL THE HIGHEST QUALITY LIGHT FIXTURES AS SHOWN. TYPICAL FOR EXISTING LOCKER ROOMS.
- \cdots 4 REFER TO LIGHTING CONTROL DETAIL E-502/6 FOR WHITE COLLAR
- EXTEND EXISTING LIGHTING CONTROL CIRCUIT TO RELOCATED LIGHT FIXTURES. UTILIZE EXISTING LINE VOLTAGE LIGHTING CONTROL
- EXTEND EXISTING LIGHTING CONTROL CIRCUIT TO RELOCATED LIGHT FIXTURES. PROVIDE NEW SPST LIGHTING CONTROL DEVICES AS
- REFER TO LIGHTING CONTROL DETAIL E-502/7 FOR MEN'S LOCKER ROOM EXPANDED, 1213.
- REFER TO LIGHTING CONTROL DETAIL E-502/9 FOR FITNESS ROOM,
- REFER TO LIGHTING CONTROL DETAIL E-502/1 FOR PRIVATE OFFICE,
- REFER TO LIGHTING CONTROL DETAIL E-502/13 FOR BUNK ROOM, 1214.
- REFER TO LIGHTING CONTROL DETAIL E-502/4 FOR LAUNDRY ROOM,
- 12 REFER TO LIGHTING CONTROL DETAIL E-502/2 FOR CID VESTIBULE,
- 13 REFER TO LIGHTING CONTROL DETAIL E-502/10 FOR CORRIDOR, 1215.

14 REFER TO LIGHTING CONTROL DETAIL E-502/3 FOR RESTROOM,

SHEET NOTES NOT USED:

KEY PLAN

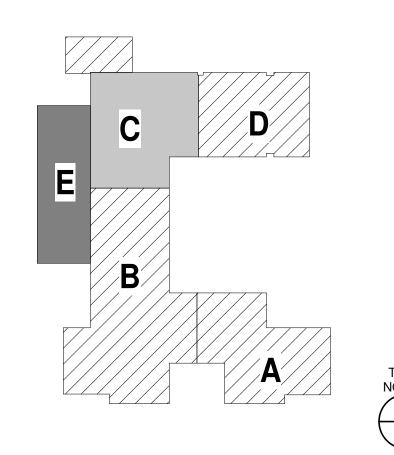

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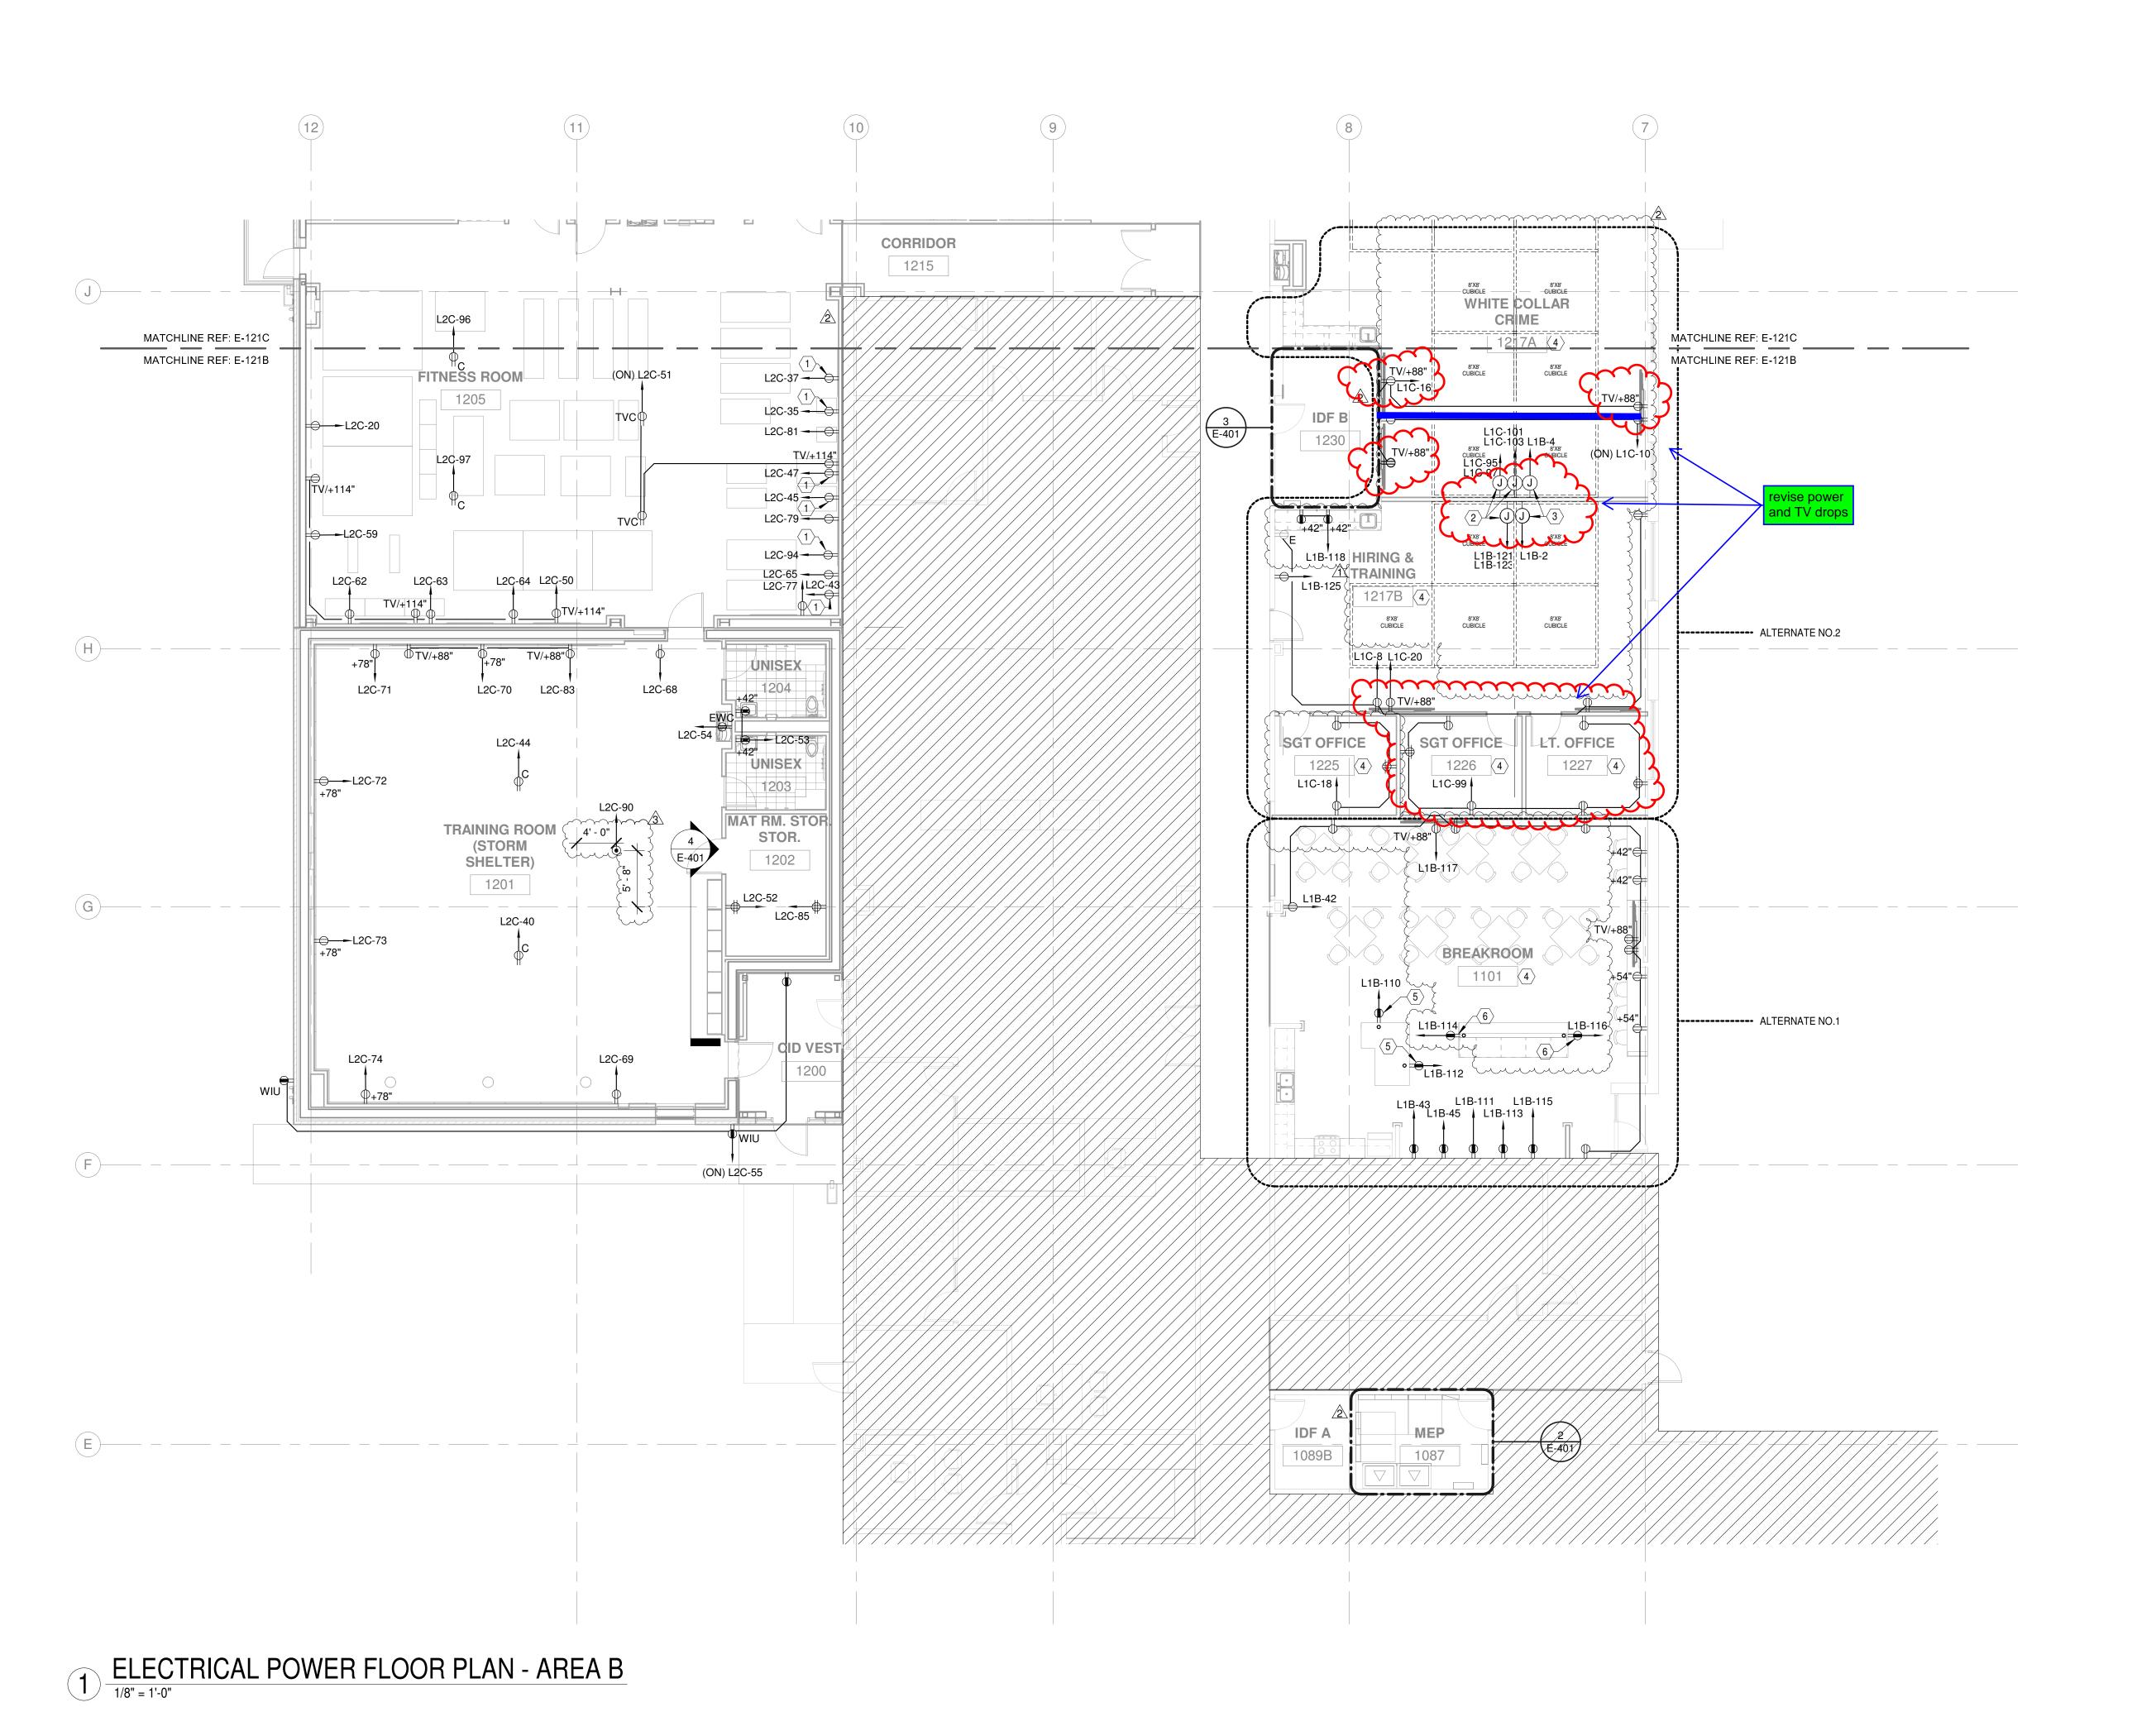
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PLAN - AREA C

ELECTRICAL

LIGHTING CEILING



- A. REFER TO SHEET EG-001 FOR GENERAL NOTES AND LEGEND.
- B. SUBSCRIPT: E = EXISTING TO REMAIN R = RELOCATED

ER = EXISTING TO BE RELOCATED.

C. SHEET NOTES LOCATED NEXT TO ROOM NAME / ROOM NUMBERS DEFINE REQUIREMENTS FOR THE ROOM.

EC = EXISTING TO REMAIN, CEILING MOUNT.



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SHEET NOTES

- 1 PROVIDE DEDICATED RECEPTACLE FOR EXERCISE EQUIPMENT.

 2 PROVIDE JUNCTION BOX WITH TWO (2) CIRCUITS FOR WALL MOUNTED FURNITURE WHIP. PROVIDE 2 #10, #10N, #10G, 3/4"C. FINAL PLACEMENT TO BE COORDINATED WITH OWNER'S FURNITURE PACKAGE PRIOR TO ROUGH-IN INSTALLATION. ELECTRICIAN IS RESPONSIBLE FOR ROUTING WHIPS, TERMINATING, AND ENERGIZING
- PROVIDE JUNCTION BOX FOR WALL MOUNTED FURNITURE WHIP.
 PROVIDE #10, #10N, #10G, 3/4"C. FINAL PLACEMENT TO BE
 COORDINATED WITH OWNER'S FURNITURE PACKAGE PRIOR TO
 ROUGH-IN INSTALLATION. ELECTRICIAN IS RESPONSIBLE FOR
 ROUTING WHIPS, TERMINATING, AND ENERGIZING WORK STATIONS.
- EXTEND EXISTING RECEPTACLE CIRCUITS TO NEW RECEPTACLES IN THIS ROOM AS SHOWN.
- 5 PROVIDE DEDICATED RECEPTACLE. STUB UP CONDUIT FROM CRAWL SPACE TO THE INTERIOR OF THE MILLWORK. COORDINATE EXACT LOCATION WITH ARCHITECT PRIOR TO INSTALLATION. PROVIDE SEALANT TO MAKE PENETRATION WEATHER TIGHT.
- 6 PROVIDE DEDICATED RECEPTACLE. STUB UP CONDUIT FROM CRAWL SPACE TO THE INTERIOR OF THE BUFFET. COORDINATE EXACT LOCATION WITH ARCHITECT PRIOR TO INSTALLATION. PROVIDE SEALANT TO MAKE PENETRATION WEATHER TIGHT.
- 7 NOT USED.
- 8 NOT USED.

SHEET NOTES NOT USED:

WORK STATIONS.

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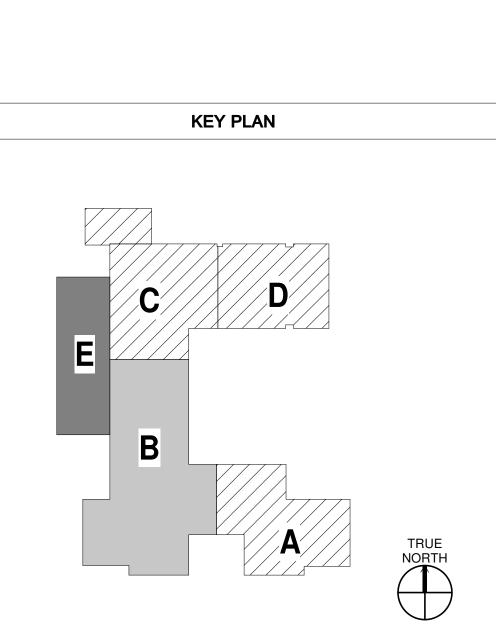
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BJ PA


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ELECTRICAL POWER FLOOR PLAN - AREA B

E-121B





A. REFER TO SHEET EG-001 FOR GENERAL NOTES AND LEGEND.

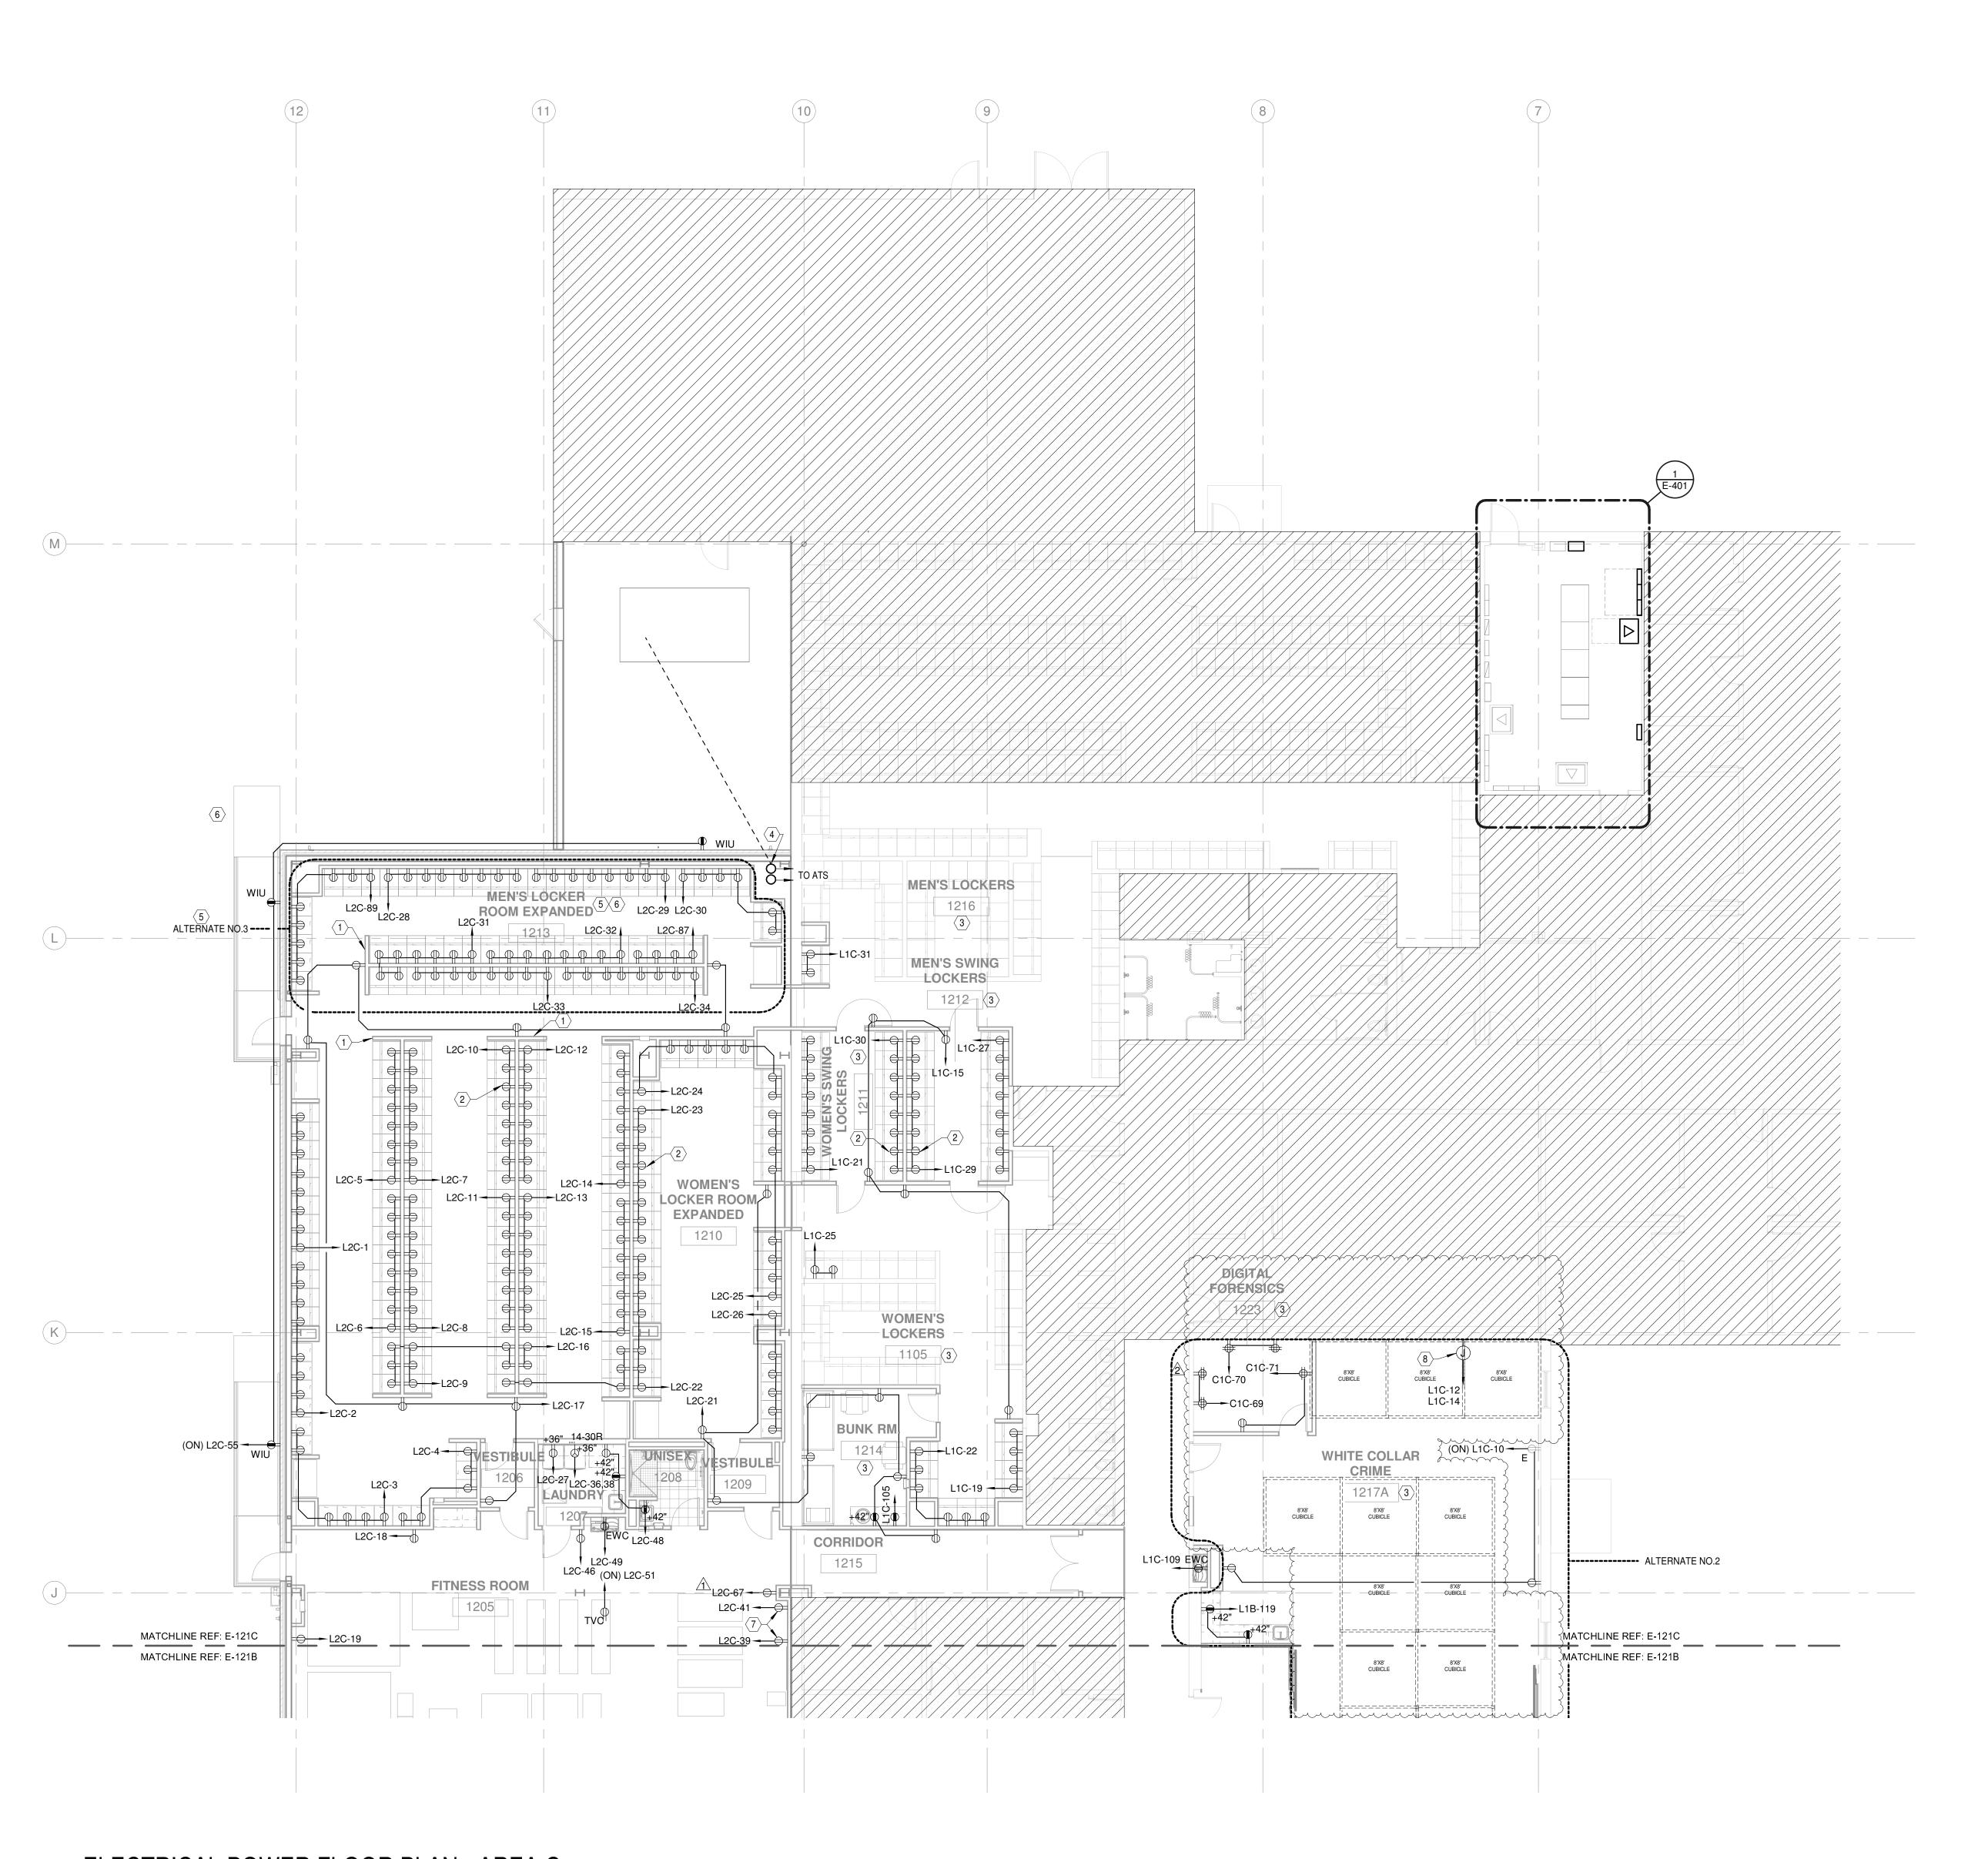GENERAL NOTES

- B. SUBSCRIPT: E = EXISTING TO REMAIN
 - R = RELOCATED
 - ER = EXISTING TO BE RELOCATED. EC = EXISTING TO REMAIN, CEILING MOUNT.
- SHEET NOTES LOCATED NEXT TO ROOM NAME / ROOM NUMBERS

DEFINE REQUIREMENTS FOR THE ROOM.





SHEET NOTES

- RUN CIRCUITS FROM OVERHEAD CEILINGS DOWN FULL HEIGHT WALL PORTION LOCATED ON THE END OF LOCKER BANKS TO RECEPTACLES.
- PROVIDE RECEPTACLE FOR LOCKER WITH TOP OF BOX AT 5'-6" AFF. COORDINATE REQUIREMENTS WITH SHEET A-732 AND ACTUAL PROVIDED LOCKER PRIOR TO INSTALLATION. TYPICAL FOR ALL LOCKER RECEPTACLES SHOWN UNLESS NOTED OTHERWISE.
- EXTEND EXISTING RECEPTACLE CIRCUITS TO NEW RECEPTACLES IN THIS ROOM AS SHOWN.
- CONDUIT FROM FUTURE GENERATOR TO ATS RISES TO CEILING IN CHASE. REFER TO SITE PLAN E-100 FOR ADDITIONAL INFORMATION.
- BASE BID: PROVIDE CONDUIT, RECEPTACLE BOXES, AND BLANK COVER PLATES IN LIEU OF RECEPTACLES SHOWN. ALL CIRCUITS SHALL BE BROUGHT TO THE TOP OF THE STUD WALL SEPARATING THE LOCKERS AND LEBELED FOR FUTURE EXTENSION TO LOCKER RECEPTACLE BOX.
- ALTERNATE NO.3: PROVIDE ALL LOCKER RECEPTACLES CIRCUITED AS SHOWN.
- PROVIDE DEDICATED RECEPTACLE FOR EXERCISE EQUIPMENT.
- FURNITURE WHIP. PROVIDE 2 #10, #10N, #10G, 3/4"C. FINAL PLACEMENT-TO BE COORDINATED WITH OWNER'S FURNITURE PACKAGE PRIOR TO ROUGH-IN INSTALLATION. ELECTRICIAN IS RESPONSIBLE FOR ROUTING WHIPS, TERMINATING, AND ENERGIZING WORK STATIONS.

SHEET NOTES NOT USED:

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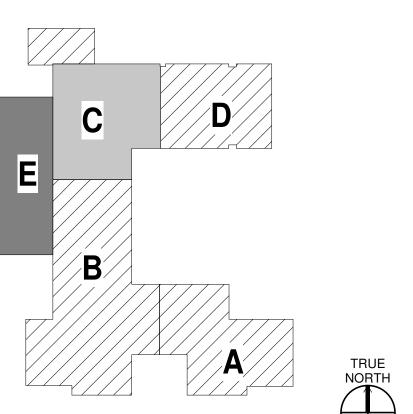
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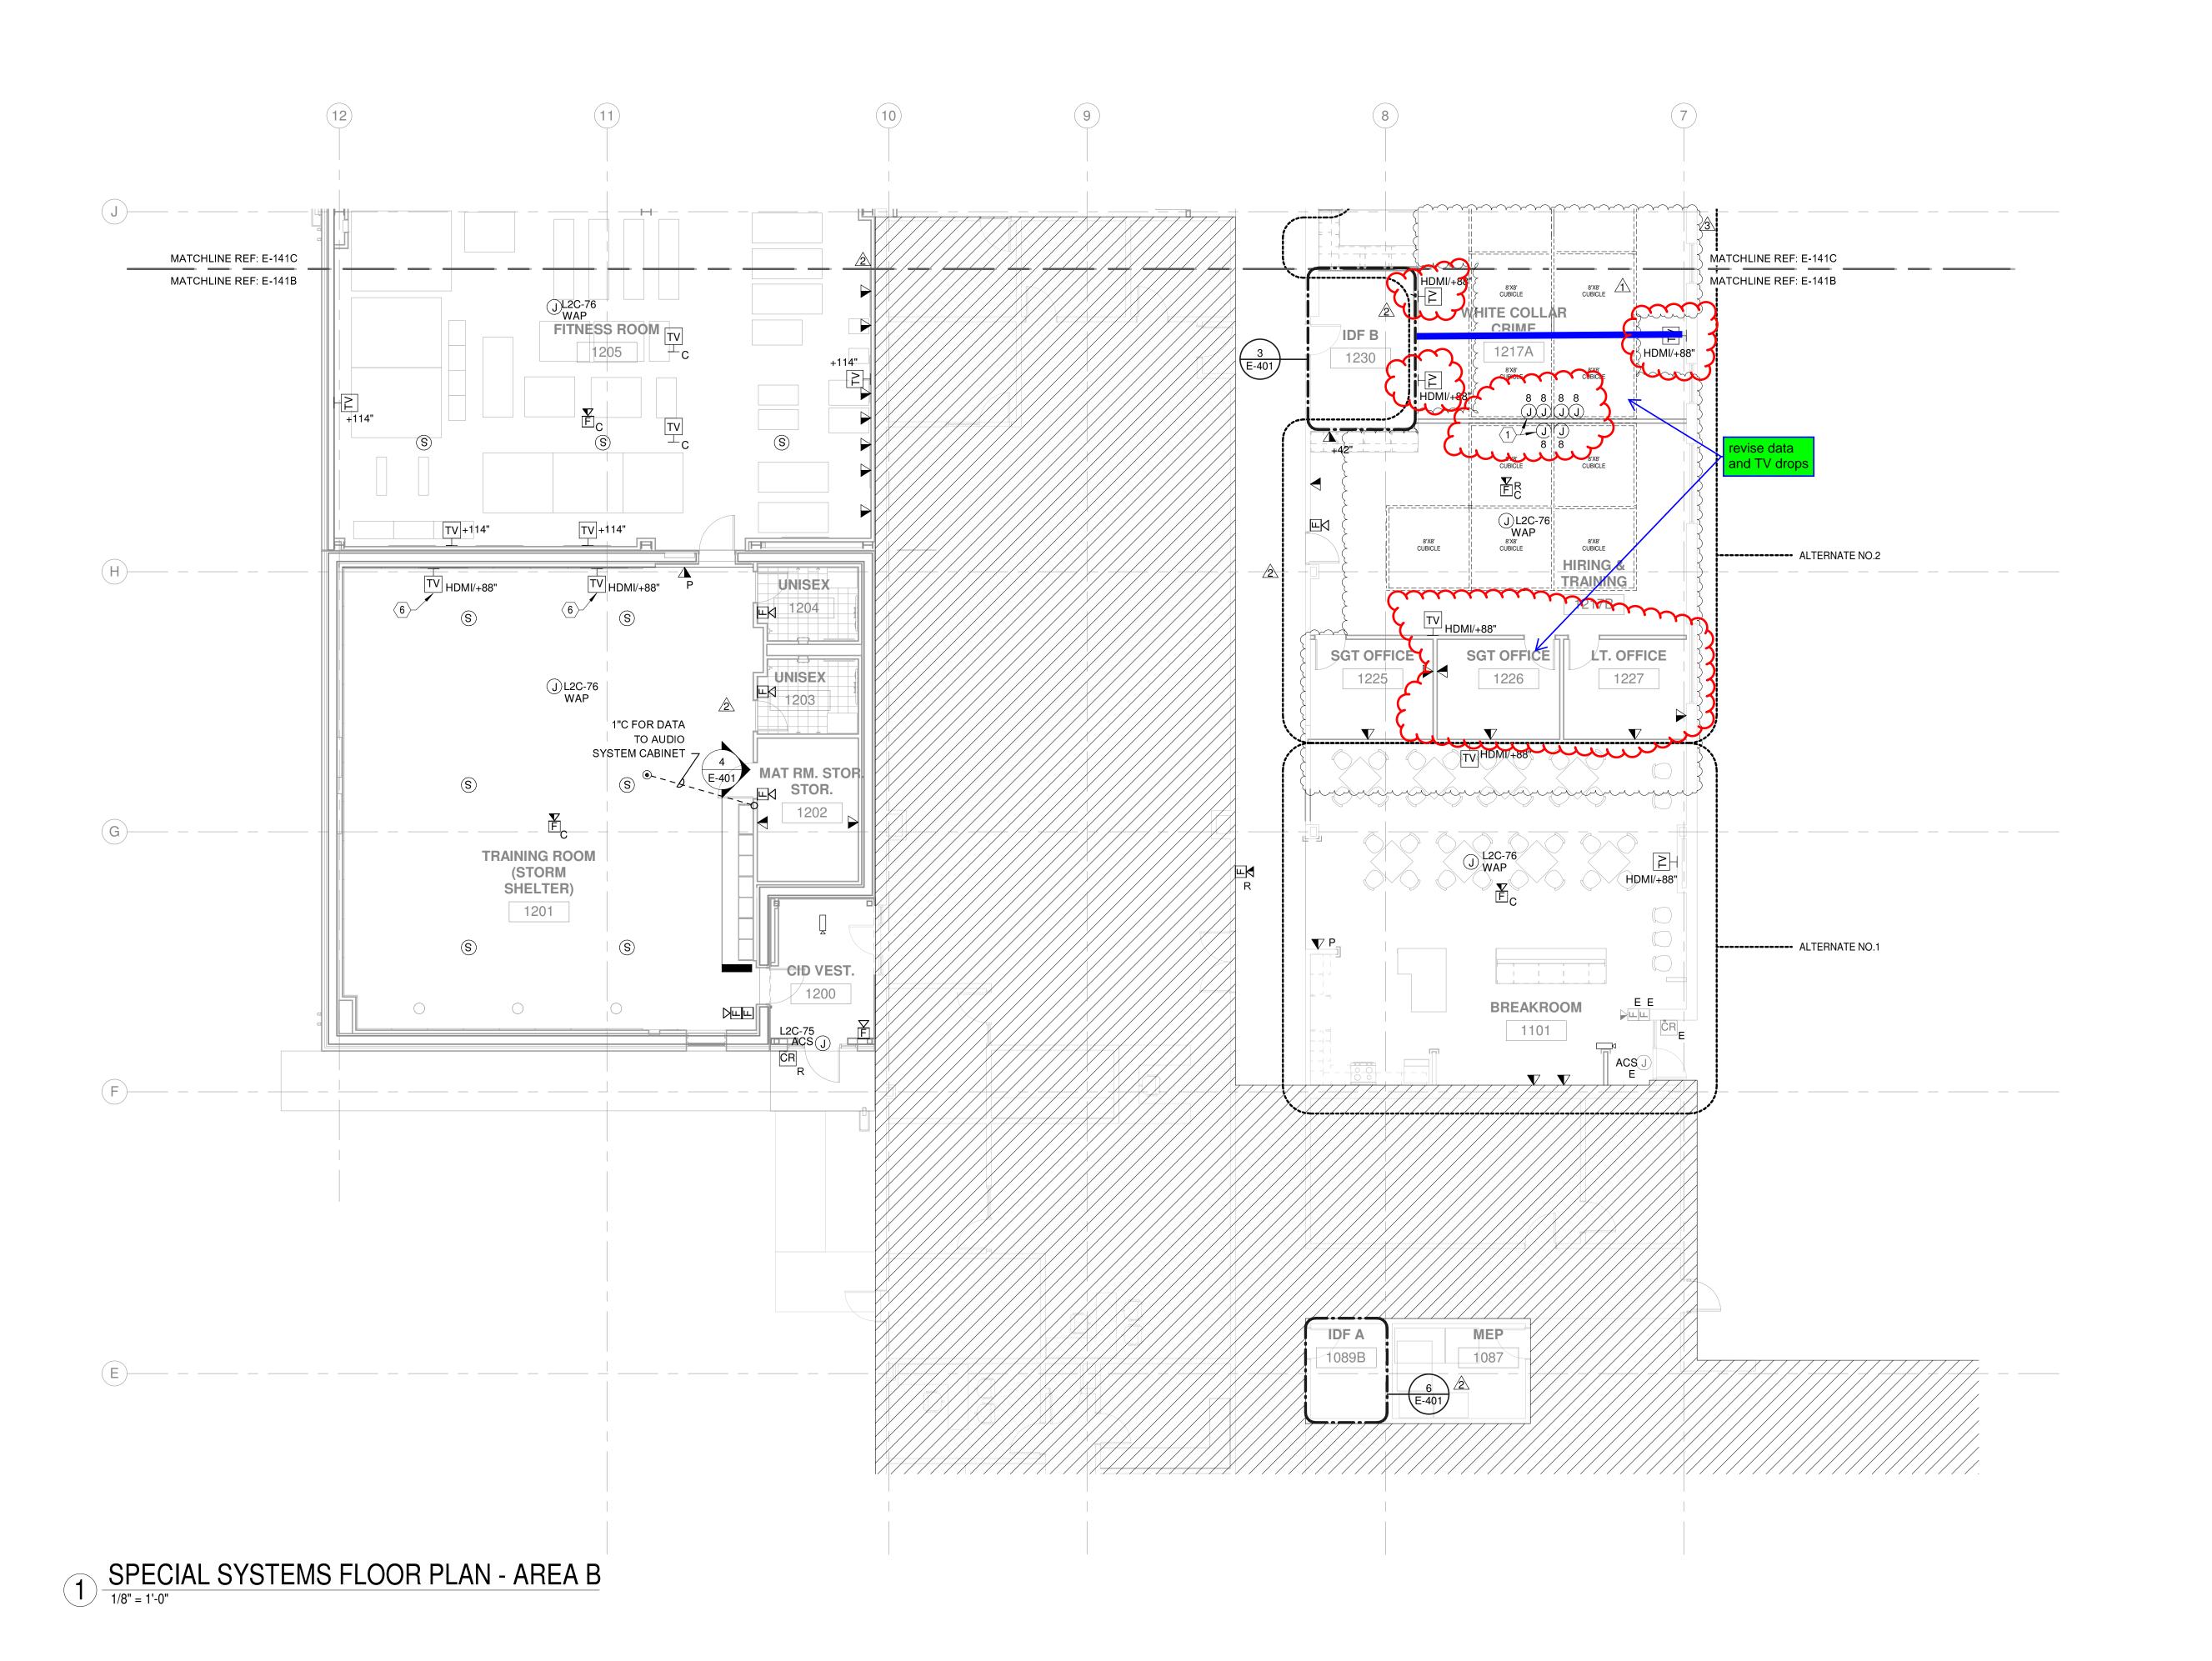
ELECTRICAL POWER FLOOR PLAN - AREA C

E-121C

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KEY PLAN





- A. REFER TO SHEET EG-001 FOR GENERAL NOTES AND LEGEND.
- B. SUBSCRIPT:

 E = EXISTING TO REMAIN

 B = BELOCATED
- R = RELOCATED
 ER = EXISTING TO BE RELOCATED.
 EC = EXISTING TO REMAIN, CEILING MOUNT.
- C. SHEET NOTES LOCATED NEXT TO ROOM NAME / ROOM NUMBERS DEFINE REQUIREMENTS FOR THE ROOM.





SHEET NOTES

1 JUNCTION BOX FOR CUBICLE DATA. PROVIDE 1-1/2"C TO CEILING.
ROUTING OF CABLING IN FURNITURE SPINE SHALL BE COORDINATED WITH FURNITURE INSTALLATION. FINAL PLACEMENT/POSITION IN WALL SHALL BE COORDINATED WITH FURNITURE INSTALLATION PRIOR TO ROUGH-IN.

- 2 NOT USED.
- 3 NOT USED.
- 5 NOT USED.


NOT USED.

6 PROVIDE 1"C FROM TV STORAGE BOX TO HDMI OUTLET IN STORAGE CUBBIES IN TRAINING ROOM. REF: 4/E-401.

KEY PLAN

SHEET NOTES NOT USED:

 $\langle 2 \rangle \langle 3 \rangle \langle 4 \rangle \langle 5 \rangle$

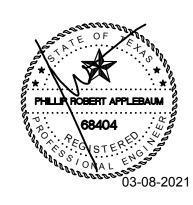

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client / owner

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McKINNEY POLICE DEPARTMENT

project

McKINNEY PUBLIC SAFETY BUILDING PHASE 5

2200 TAYLOR BURK DR. McKINNEY, TEXAS 75071

revision no:	issue date:
ASI #1	11/11/20
PR 01	03/01/21
PR 02	03/08/21

issue date:
10/02/2020
vai project no:

vai project no:

38326.001

drawn by: check
B.I

issue title:
ISSUED FOR CONSTRUCTION


sheet title:

SPECIAL SYSTEMS
FLOOR PLAN - AREA

E-141B

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3/8/2021 1:04:10 PI

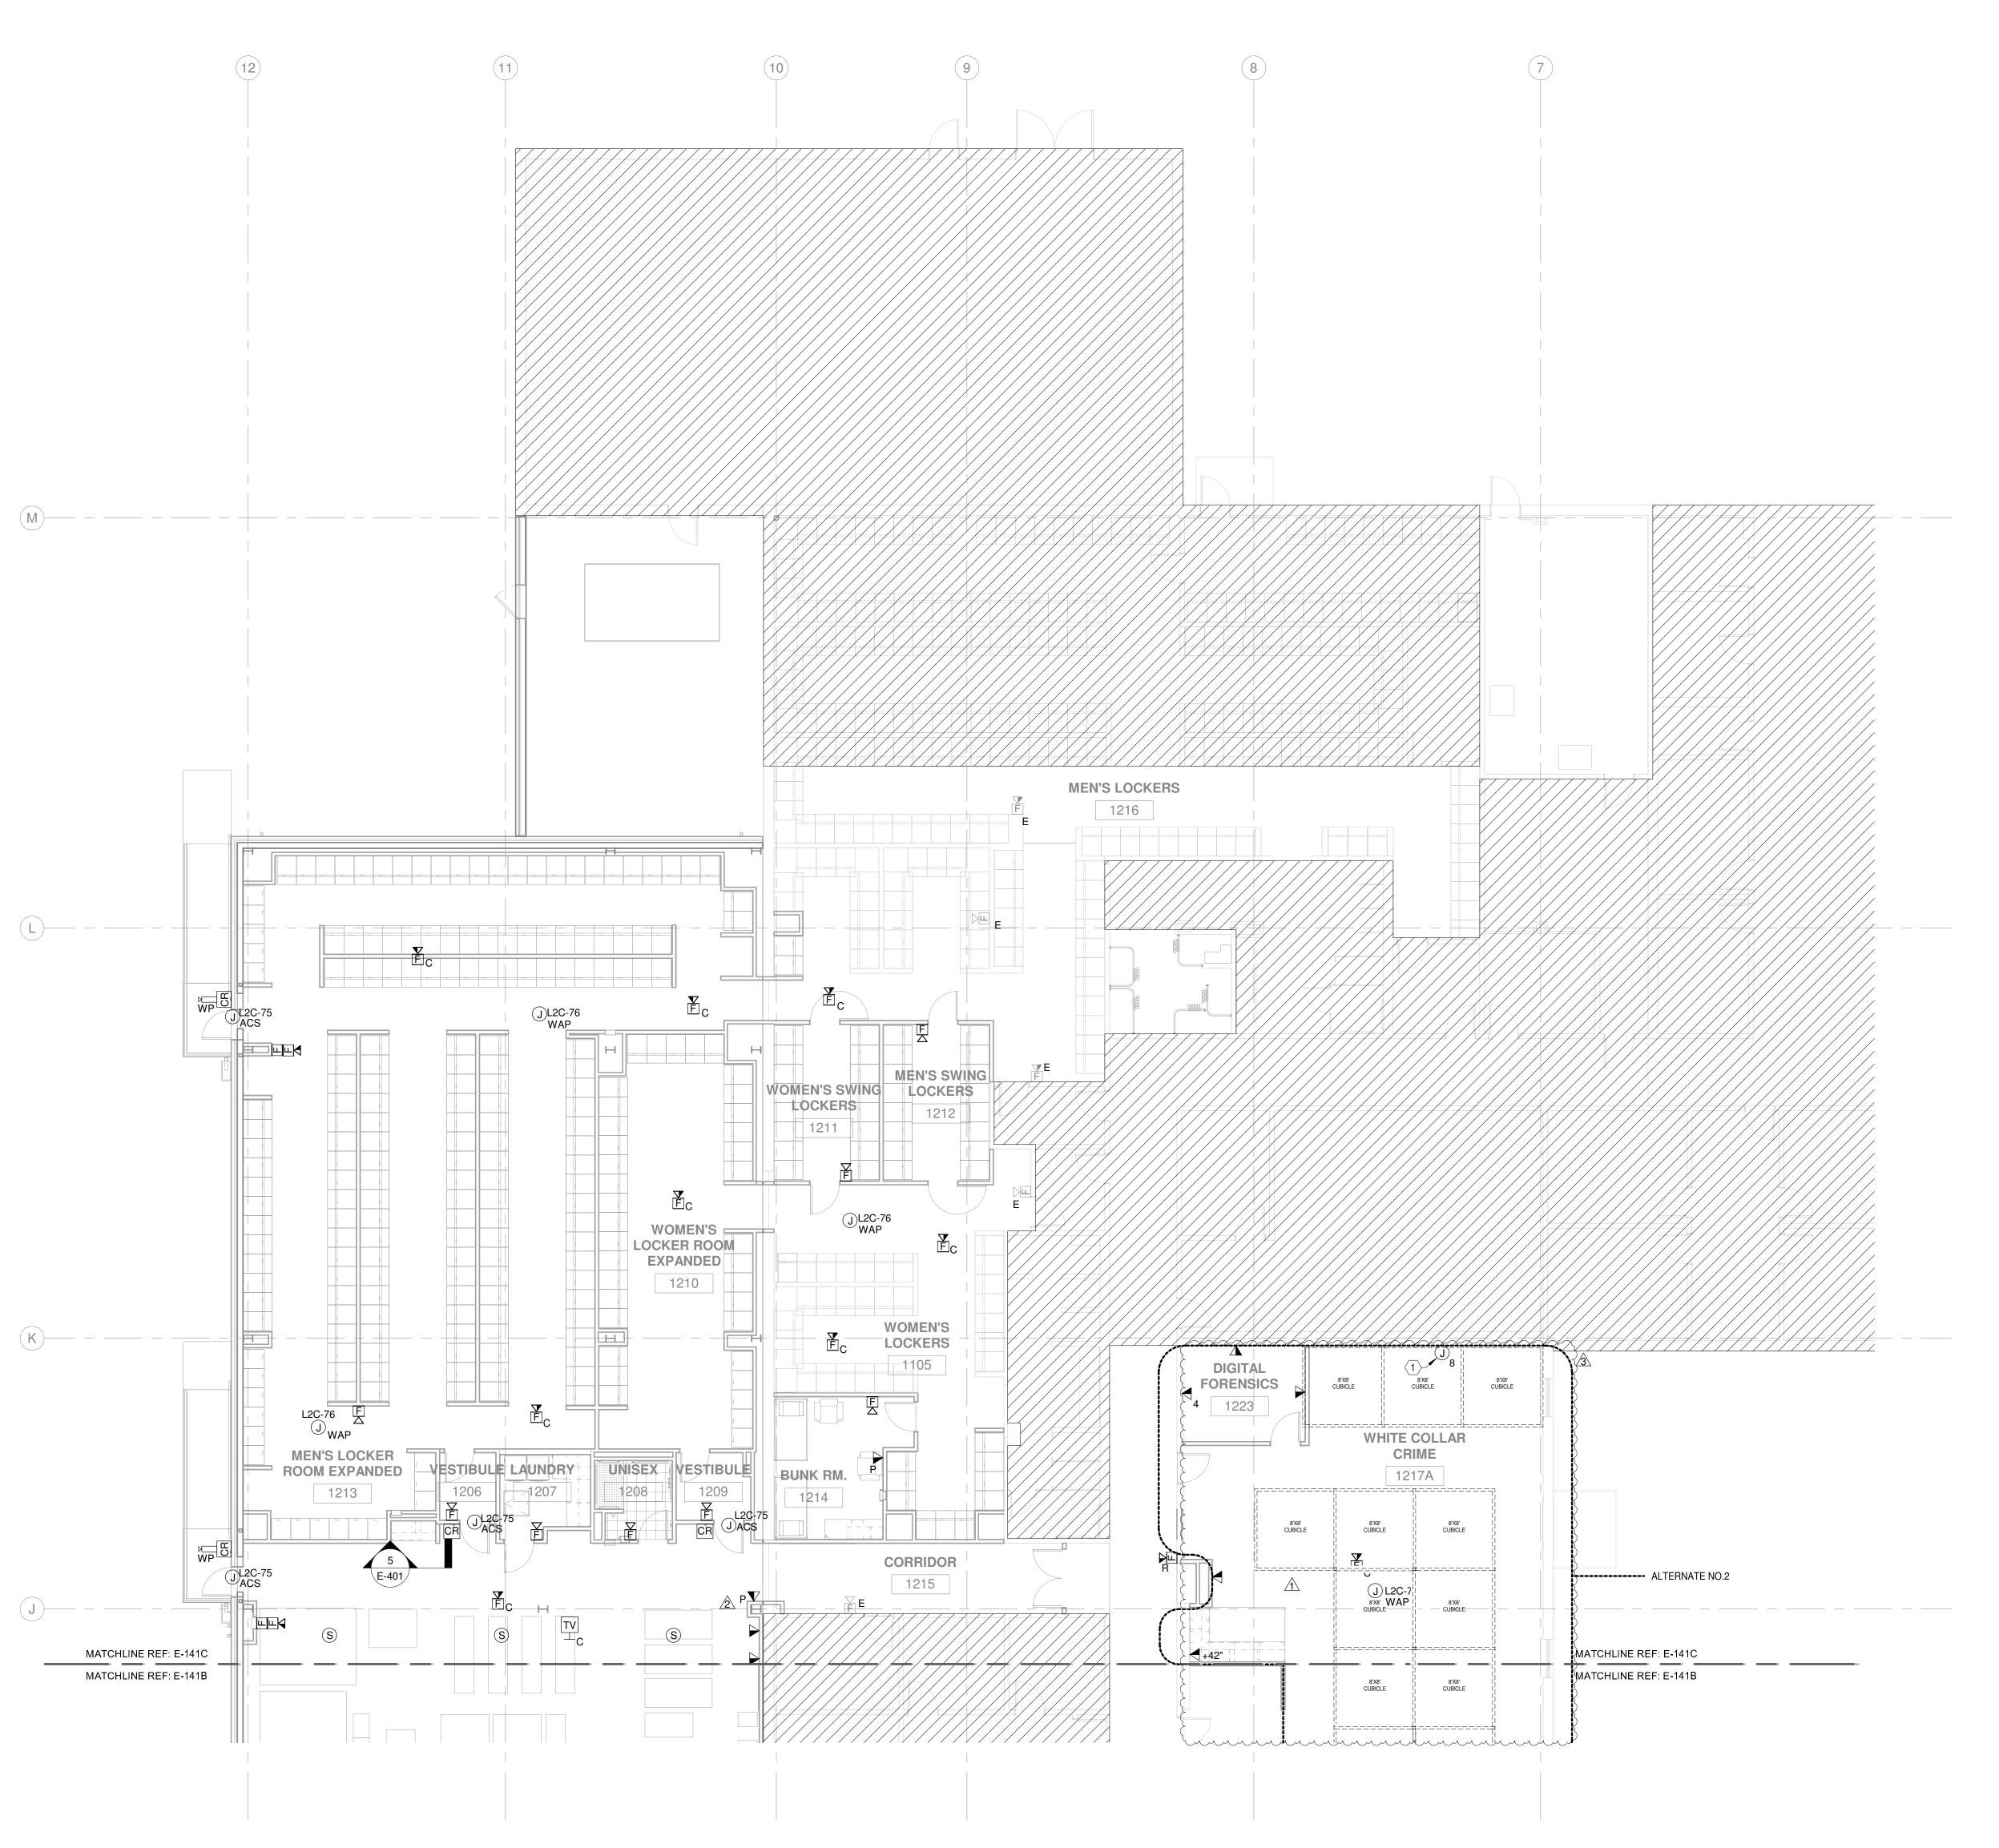

- A. REFER TO SHEET EG-001 FOR GENERAL NOTES AND LEGEND.
- B. SUBSCRIPT: E = EXISTING TO REMAIN
- R = RELOCATED
- ER = EXISTING TO BE RELOCATED. EC = EXISTING TO REMAIN, CEILING MOUNT.

SHEET NOTES LOCATED NEXT TO ROOM NAME / ROOM NUMBERS DEFINE REQUIREMENTS FOR THE ROOM.

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1201 NORTH BOWSER ROAD RICHARDSON, TX 75081-2275

(214) 346-6200

SHEET NOTES

JUNCTION BOX FOR CUBICLE DATA. PROVIDE 1-1/2"C TO CEILING. ROUTING OF CABLING IN FURNITURE SPINE SHALL BE COORDINATED WITH FURNITURE INSTALLATION. FINAL PLACEMENT/POSITION IN WALL SHALL BE COORDINATED WITH FURNITURE INSTALLATION PRIOR TO ROUGH-IN.

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McKINNEY POLICE DEPARTMENT

McKINNEY PUBLIC SAFETY BUILDING PHASE 5

2200 TAYLOR BURK DR. McKINNEY, **TEXAS 75071**

11/11/20 PR 02 03/08/21

KEY PLAN

vai project no:

38326.001

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SPECIAL SYSTEMS FLOOR PLAN - AREA

E-141C

SPECIAL SYSTEMS FLOOR PLAN - AREA C